

CITY OF ALAMO HEIGHTS

COMMUNITY DEVELOPMENT SERVICES DEPARTMENT
6116 BROADWAY
SAN ANTONIO, TX 78209
210-826-0516

Architectural Review Board Meeting Tuesday, August 18, 2020 – 5:30 P.M.

In accordance with order of the Office of the Governor issued March 16, 2020, where he temporary suspended certain provisions of the Texas Open Meetings Act, take notice that a regular meeting scheduled at 5:30 p.m. on Tuesday, August 18, 2020 will be conducted by telephone conference in order to advance the public health goal of limiting face-to-face meetings (also called "social distancing"), to slow the spread of the Coronavirus (COVID-19), to consider and act upon any lawful subjects which may come before it. There will be no public access to Alamo Heights Council Chamber.

INSTRUCTIONS FOR TELECONFERENCE: The public toll-free dial-in number to participate in the telephonic meeting is 800-717-4201 and enter access number 3446107#.

Case No. 809 F – 5945 Broadway

Request of Lyndsay A. Thorn, Architect, of ThornGraves Architects, PLLC, applicant, to modify the existing exterior and color of the commercial structure at the property located at 5945 Broadway under Chapter 2 Administration for Architectural Review.

Chapter 5 of Code of Ordinances (Buildings and Building Regulations) requires City Council to consider the ARB's recommendation for all demolition/final design review applications. Please check the ARB posted results on the City's website after the ARB meeting to confirm any future meeting dates.

Plans may be viewed online* (http://www.alamoheightstx.gov/departments/planning-and-development-services/public-notices/) and at the Community Development Services Department located at 6116 Broadway St. You may also contact Brenda Jimenez (bjimenez@alamoheightstx.gov), or Nina Shealey (nshealey@alamoheightstx.gov) by email or our office at (210) 826-0516 for additional information regarding this case. Please note that plans will not be available online for all case types and floor plans will not be available online.



Lyndsay Thorn, AIA ThornGraves Architects, PLLC 105 Montclair Ave. Alamo Heights, TX 78209

August 6, 2020

Chairman and Board Members of the Architectural Review Board of Alamo Heights.

We propose the following alterations to 5945 Broadway.

Firstly, the installation of a new permanent sign to be face-lit using existing landscape lighting. The sign is to be a 6'-0" x 4'-1 $\frac{1}{2}$ " x 6" metal framed box sign with a white acrylic face to receive a red and blue vinyl logo application. The metal frame is to be painted light gray and have a minimal 2" border on the front face of the sign. The sign is to be supported by a concrete base footing.

Secondly, we propose changing the colors of the existing façades. The current façade is a drab olive green with rust accents. The proposed façade colors are Van Deusen Blue for the main body of the building, China Red for the doors and attic vents, and Hazy Skies (a light off-white color) for the trim. Please see the provided elevations for reference.

Thank you for your consideration,

Landsur Phier

Lyndsay A. Thorn

BSc., (Hons) BArch., (M.Arch.US), AIA, Architect

Principal

ThornGraves Architects, PLLC

Office: (210) 222-0194



5945 Broadway
Proposed Exterior Color: Van Deusen Blue









KING & COUNTRY

5945 BROADWAY, SAN ANTONIO, TX 78209

DESIGN TEAM

THORN+GRAVES ARCHITECTS 105 MONTCLAIR AVE SAN ANTONIO, TX 78209 TEL: 210.222.0194

WRITTEN DESCRIPTION OF WORK

Sheet List

SITE PLAN & SITE DETAILS

EXTERIOR ELEVATIONS

DOOR & WINDOW SCHEDULE

SECTIONS & DETAILS

COVER SHEET

DEMO PLANS

DETAILS

FLOOR PLANS

Sheet Name

LIFE SAFETY AND CODE INFORMATION

INTERIOR RENOVATION AND EXTERIOR MAINTENANCE. ADDITION OF ACCESSIBLE RAMP AND ENTRANCE, EXTENSION OF EXISTING PORCH.

SHEET INDEX

Sheet Number

A0.1D

A2.1

A3.1

A5.1

ALLOWANCES

ALLOW \$_____ FOR ___

ADD ALTERNATES PROVIDE LINE ITEM ENTRY FOR DEMOLITION AND REMOVAL OF TWO EXISTING "PORTABLE" STRUCTURES FROM SITE.

OWNER SUPPLIED AND INSTALLED (OSI)

OFFICE 1

B 207 SF

3. VENDING MACHINES

LIFE SAFETY INFORMATION

NOTE: THE FOLLOWING ITEMS ARE NOT PROVIDED BY THE GENERAL CONTRACTOR. BUT REQUIRE COORDINATION FOR PRODUCT REQUIREMENTS AND INSTALLATION METHODS. 1.OFFICE COPIERS, PRINTERS, SCANNERS AND MISC. OFFICE EQUIPMENT, UNLESS OTHERWISE NOTED.



TDLR: TABS2020020443

GENERAL NOTES

GENERAL

• WHILE THE ARCHITECT SHALL ENDEAVOR TO MAKE REASONABLE AND PRUDENT ASSUMPTIONS DURING THE COURSE OF THE DESIGN PROCESS UNFORESEEN. CONDITIONS MAY EXIST, SUCH CONDITIONS INCLUDE, BUT ARE NOT LIMITED TO, UNUSUAL SUBSURFACE OR OTHERWISE CONCEALED PHYSICAL CONDITIONS. SHOULD CONDITIONS BE ENCOUNTERED THAT ARE MATERIALLY DIFFERENT. THE GENERAL CONTRACTOR SHALL NOTIFY THE CLIENT AND ARCHITECT OF ANY SUCH CONDITION AND POTENTIAL CHANGE IN SCOPE OF WORK AND TIME REQUIRED TO COMPLETE THE WORK GENERAL CONTRACTOR SHALL REPORT ANY CONFLICTS, OMISSIONS OR DISCREPANCIES

TO THE ARCHITECT IMMEDIATELY FOR REVIEW & CLARIFICATION BEFORE PROCEEDING WITH THAT PORTION OF THE WORK. • THIS SET OF DOCUMENTS IS CONSIDERED A "DESIGN/BUILD - BUILDER'S SET" OF DRAWINGS, INCLUDING ALL NECESSARY MEP SYSTEMS, IN IS INTENDED THAT THE ONTRACTOR PROVIDE A COMPLETE BUILDING IN CONFORMANCE WITH GOVERNING CODES, FINISHED, CLEANED, AND READY FOR OCCUPANCY. UNLESS OTHERWISE INDICATED (SUCH AS "NIC" OR "BY OWNER") CONTRACTOR SHALL FURNISH AND INSTALL ALL MATERIALS AND EQUIPMENT GENERAL CONTRACTOR SHALL COORDINATE WORK AMONG ALL TRADES, AND SHALL

COORDINATE THE ENGINEERING OF HVAC, LIGHTING, AND PLUMBING SYSTEMS BY LICENSED VENDORS. · GENERAL CONTRACTOR SHALL TAKE RESPONSIBILITYOF FAMILIARIZING HIMSELF/HERSELF WITH THE BUILDING AND SITE. ADDITIONAL COSTS RESULTING FROM THE CONTRACTOR'S FAILURE TO DO SO SHALL BE PAID FOR BY THE CONTRACTOR. · VERIFY EXISTING SITE CONDITIONS AND ALL DIMENSIONS ON PLAN PRIOR TO BEGINNING WORK. EACH SUBCONTRACTOR SHALL VERIFY THE DIMENSIONS AND CONDITIONS OF CONSTRUCTION NECESSARY FOR HIS/HER WORK TO BE COMPLETE AND APPROPRIATE.

DISCREPANCIES TO THE OWNER/ARCHITECT FOR RESOLUTION. ALL CHANGES AND MODIFICATIONS TO THE SCOPE OF WORK SHALL BE SUBMITTED TO THE ARCHITECT AS A CHANGE ORGDER FOR APPROVAL BY THE OWNER PRIOR TO COMMENCEMENT OF THAT PORTION OF WORK. PRODUCTS: MEANS NEW MATERIAL, MACHINERY, COMPONENTS, EQUIPMENT, FIXTURES, AND SYSTEMS FORMING THE WORK, BUT DOES NOT INCLUDE MACHINERY AND EQUIPMENT USED FOR PREPARATION, FABRICATION, CONVEYING AND ERECTION OF THE WORK.

COMMENCEMENT OF WORK INDICATES ACCEPTANCE OF CONDITIONS. REPORT ANY

PRODUCTS MAY ALSO INCLUDE EXISTING MATERIALS OR COMPONENTS REQUIRED FOR • FURNISH: TO SUPPLY AND DELIVER, UNLOAD, INSPECT FOR DAMAGE. • INSTALL: TO UNPACK, ASSEMBLE, ERECT, APPLY, PLACE FINISH, CURE, PROTECT, CLEAN, AND MAKE READY FOR USE. PROVIDE: TO FURNISH AND INSTAL

• GENERAL CONTRACTOR IS RESPONSIBLE FOR OBTAINING INSURANCE TO PROTECT THE

PUBLIC AND PERSONNEL FROM INJURY INSURANCE SHALL PROTECT AND HOLD

OCCUPANCY BY CLIENT, PRIOR TO ISSUANCE OF SUBSTANTIAL COMPLETION.

HARMLESS THE OWNER, OWNER'S REPRESENTATIVES ARCHITECT ARCHITECT'S REPRESENTATIVE AND CONSULTANTS FROM ANY LIABILITY DUE TO PROPERTY DAMAGE OR INJURY UNTIL THE OWNER HAS TAKEN POSSESSION OF THE BUILDING GENERAL CONTRACTOR TO NOTIFY OWNER IN WRITING OF ANY VALUE ENGINEERED ITEMS INCLUDED IN BID. AND OF ANY ITEMS OMITTED FROM BID. GENERAL CONTRACTOR TO COORDINATE TIMES OF OPERATION, CONSTRUCTION ACCESS & SITE DELIVERY WITH OWNER AND ARCHITECT GENERAL CONTRACTOR IS RESPONSIBLE FOR CLEANING ALL WORK TO BE READY FOR

PROCESS MEETINGS, SUBMITTALS, AND DOCUMENTS

• ALTERNATES AND SUBSTITUTIONS ARE TO BE CLEARLY IDENTIFIED AS SUCH, WHEN PROPOSED AND SUBMITTED BY THE GENERAL CONTRACTOR AND WILL BE REVIEWED, ACCEPTED OR REJECTED AT THE CLIENT'S OPTION. · SHOP DRAWINGS (WHEN APPLICABLE) ARE REQUIRED FOR ARCHITECTS REVIEW FOR THE FOLLOWING: ALL EXTERIOR & INTERIOR WINDOWS AND STOREFRONTS. ALL FINISH MATERIALS, ALL LIGHT FIXTURES, HVAC SYSTEMS, CABINETRY LOCATIONS AND TRUSS SYSTEMS. ADDITIONAL SHOP DRAWINGS MAY BE REQUIRED BY OTHER TRADES. REFER TO CIVIL, STRUCTURAL, PLUMBING, MECHANICAL, AND ELECTRICAL, AS REQUIRED.

PERMITS, FEES, SURVEYS

• CONTRACTOR SHALL OBTAIN A BUILDING PERMIT PRIOR TO BEGINNING WORK. HVAC, PLUMBING, ELECTRICAL AND SPECIALTY PERMITS SHALL BE THE RESPONSIBILITY OF SUBCONTRACTOR. ALL PERMIT FEES ARE TO BE INCLUDED IN BID AMOUN' ALL PERMITTING APPLICATIONS TO BE SUBMITTED TO THE CITY, COUNTY, OR ENTITY

GOVERNING THE PERMITTING PROCESS AT TIME OF PERMIT APPLICATION.

SHALL NOTIFY THE ARCHITECT IN WRITING.

STATE AND LOCAL CODES.

CLIENT WILL RETAIN, AT THEIR EXPENSE, INSPECTORS ACCEPTABLE TO CITY AUTHORITIES WHERE INDEPENDENT INSPECTORS ARE REQUIRED. GENERAL CONTRACTOR SHALL COORDINATE AND FACILITATE INSPECTIONS ON A TIMELY BASIS, AS NOT TO DELAY THE PROGRESS OF WORK. THE GENERAL CONTRACTOR SHALL BE RESPONSIBLE FOR SCHEDULING REQUIRED INSPECTIONS WITH GOVERNMENT REVIEWING AGENCIES AND JURSIDICTIONS. GENERAL CONTRACTOR IS TO POST IN A CENTRAL LOCATION, CLEARLY VISIBLE, ALL · GENERAL CONTRACTOR SHALL REVIEW ALL CODE ANALYSIS INFORMATION PROVIDED. ALL NEW WORK SHALL BE IN ACCORDANCE WITH GOVERNING CODES. SHOULD A

EXISTING CONDITIONS

• ALL TRASH & EXCESS BUILDING MATERIAL SHALL BE REMOVED FROM THE JOB SITE AND DISPOSED OF IN A LEGAL MANNER BY THE CONTRACTOR UNLESS OTHERWISE INDICATED • ALL ROUGH OPENINGS CREATED THROUGH NEW WORK SHALL BE SECURED DURING NON-WORKING HOURS. REPAIR OR REPLACEMENT OF DAMAGE TO OWNER'S PROPERTY DUE TO CONTRACTOR'S NEGLIGENCE NOT PROPERLY SECURING SITE SHALL BE PAID FOR BY THE

DISCREPANCY BE NOTED BY THE GENERAL CONTRACTOR, THE GENERAL CONTRACTOR

<u>UTILITIES</u>
• GENERAL CONTRACTOR TO SITE VERIFY LOCATIONS OF ALL UNDERGROUND UTILITIES PRIOR TO START OF FOUNDATION WHERE NEW ELECTRICAL GENERATOR FOUNDATION IS ALL NEW AND EXISTING UTILITIES SHALL BE RAISED ACCORDING TO LATEST APPLICABLE CODES AND SITE CONDITIONS. CHECK VALVES AND BACK FLOW PREVENTION DEVICES SHALL BE INSTALLED ON SANITARY SEWER AND POTABLE WATER LINES, RESPECTIVELY, PER APPLICABLE CODES OBTAIN LICENSED VENDOR TO INSTALL SEWER LINES AND CONNECTIONS TO MEET ALL

FOUNDATION

• STRUCTURAL ELEMENTS TO BE DESIGNED BY A LICENSED STRUCTURAL ENGINEER

• STRUCTURAL ELEMENTS TO BE DESIGNED BY A LICENSED STRUCTURAL ENGINEER AUTHORIZED TO DO WORK IN THE AREA OF CONSTRUCTION - REFER TO STRUCTURAL ENGINEER DRAWINGS. THIS WORK TO BE COORDINATED WITH ELECTRICAL ENGINEER AND SUBCONTRACTOR RETAINED BY G.C.

ROUGH OPENINGS

COORDINATE ROUGH OPENING DIMENSIONS FOR DOOR AND WINDOW OPENINGS WITH REQUIREMENTS FOR OPENINGS BY DOOR AND WINDOW MANUFACTURERS. SELECTION OF DOOR AND WINDOW MANUFACTURERS IS SUBJECTED TO ARCHITECT'S AND OWNER'S • PROVIDE BLOCKING AT ALL CABINET LOCATIONS. VERIFY WALL CABINET HEIGHTS PRIOR TO INSTALLATION OF BLOCKING. PROVIDE BLOCKING AT ALL TOILET LOCATIONS FOR H/C HANDRAIL/GRAB-BARS AND • PROVIDE BLOCKING AT ALL MIRROR LOCATIONS.

CONCRETE FLATWORK

• PROVIDE LIGHT BROOM FINISH ON EXTERIOR CONCRETE PADS & WALKWAYS. ALL WALKWAYS SHALL HAVE CONTROL JOINTS EVERY 6' MAX. (5' PREFERRED) WITH EXPANSION JOINTS EVERY 30' MAX. (25' PREFERRED).

WINDOWS & DOORS

• UNLESS OTHERWISE NOTED ON PLANS, DOORS SHALL BE INSTALLED 4" FROM ADJACENT WALL TO HINGE SIDE OF DOOR. SUBMIT SAMPLES TO ARCHITECT FOR REVIEW AND APPROVAL REFER TO PLANS FOR STOREFRONT, WINDOWS AND DOOR SIZES. • PROVIDE DOOR HARDWARE THROUGHOUT. REFER TO HARDWARE SCHEDULE AND

SPECIFICATIONS • PROVIDE PRE-HUNG DOORS WITH THREE BUTT HINGES AT ALL INTERIOR DOOR LOCATIONS (REFER TO PLANS FOR SIZE AND SWING OF DOOR). PROVIDE T-ASTRAGALS AT ALL PAIR OF DOORS.

PROVIDE EXTERIOR WINDOW AND DOOR TRIM AS RECOMMENDED BY THE

 INTERIOR DOORS - REFER TO ARCHITECT DOOR SCHEDULE. ALL WINDOWS AND DOORS THROUGHOUT SHALL COMPLY WITH APPLICABLE CODES REGARDING EMERGENCY ENTRY AND EGRESS.

PLUMBING - REFER TO M.E.P. DRAWINGS. HEATING - REFER TO M.E.P. DRAWINGS

• PROVIDE DOOR STOPS AT ALL DOOR LOCATIONS.

<u>ELECTRICAL AND LIGHT FIXTURE</u> - REFER TO M.E.P. DRAWINGS • PROVIDE INSULATION AS REQUIRED ON PLANS AND PROJECT MANUAL. SOUND ATTENUATION BARRIER AT ALL PARTITIONS AS INDICATED ON FLOOR PLANS - SEE WALL

WATER
• PROVIDE ELECTRICAL INSTANT HOT WATER HEATERS TO MEET ALL CITY AND LOCAL PROVIDE VACUUM BREAKER DEVICE ON ALL HOSE BIBS.

PROVIDE 5/8" GYPSUM WALLBOARD AT ALL LOCATIONS. TAPE AND FLOAT ALL JOINTS.

SUBMIT SHOP DRAWINGS FOR APPROVAL BY CLIENT AND ARCHITECT FOR ALL CABINET

<u>CABINETS</u>
• PROVIDE STAIN GRADE CABINETS WHERE INDICATED ON PLANS. • PROVIDE FRONT PANELS TO BE SELECTED BY ARCHITECT, CONCEALED HINGES, FULL EXTENSION GLIDES, ADJUSTABLE SHELVES, BLIND CORNERS, AND COMMERCIAL GRADE

• PROVIDE 3/4" GREENBOARD AT ALL "WET" AND UTILITY "DRIP DRY" LOCATIONS.

AND COUNTER LOCATIONS, PRIOR TO MANUFACTURE AND INSTALL. CORROBORATE DIMENSIONS ON SITE. MILLWORK

• SUBMIT SHOP DRAWINGS FOR ALL REQUIRED MILLWORK.

ALL EXPOSED SURFACES TO RECEIVE PLASTIC LAMINATE.

• TAPE, FLOAT, AND LIGHT TEXTURE ALL INTERIOR WALLS AND GYP. BD. CEILINGS -TEXTURE TO BE SELECTED BY ARCHISTECT. PROVIDE SAMPLES TO CLIENT FOR APPROVAL BEFORE INSTALL. • PROVIDE ONE COAT PRIMER AND TWO COATS PAINT AT ALL LOCATIONS TO BE PAINTED. • PROVIDE FLAT LATEX AT WALL AND CEILING LOCATIONS. REFER TO ROOM FINISH SCHEDULE - ALL NEW AND EXISTING STEEL ERECTED DURING CONSTRUCTION TO BE

• THE CONTRACTOR IS RESPONSIBLE FOR CLEANING ALL NEW WORK, TO BE READY FOR OCCUPANCY BY OWNER, PRIOR TO ISSUANCE OF SUBSTANTIAL COMPLETION

FLOORING
• PREPARE ALL FLOOR SUBSTRATE FOR NEW MATERIAL INSTALL, REFER TO PLANS FOR MATERIAL TO BE INSTALLED, FINAL SELECTIONS BY CLIENT AND ARCHITECT. **BRICKS & PAVERS**

WORKING IN SAN ANTONIO

• ALL BUILDING PERMITS MUST BE POSTED ON THE JOB IN ORDER TO GET REQUIRED INSPECTIONS. • CALL AT LEAST 24 HOURS IN ADVANCE FOR INSPECTIONS, UNLESS YOU MAKE SPECIFIC ARRANGEMENTS WITH THE INDIVIDUAL INSPECTOR. WHEN CALLING INTO THE OFFICE FOR INSPECTIONS. PLEASE HAVE THE PERMIT NUMBER TO GIVE CONTRACTOR MUST USE CONSTRUCTION EQUIPMENT AND VEHICLES WHICH CAN TRANSVERSE TH CITY STREETS TO THE SITE LOCATION WITHOUT DAMAGE TO STREETS AND TREES. CLEAN THE SITE OF RUBBISH, DEBRIS, AND TRASH, INCLUDING FOOD/DRINK WRAPPERS AND CONTAINERS, DAILY, CONSTRUCTION EQUIPMENT AND MATERIALS SHALL BE STORED AND PLACED SO AS NOT TO

ENDANGER THE PUBLIC, THE WORKERS, OR THE ADJOINING PROPERTY FOR THE DURATION OF THE WASTE MATERIALS SHALL BE REMOVED IN A MANNER WHICH PREVENTS INJURY OR DAMAGES TO PERSONS, ADJOINING PROPERTIES, AND PUBLIC RIGHTS-OF-WAY. TOILET FACILITIES SHALL BE PROVIDED FOR CONSTRUCTION WORKERS AND SUCH FACILITIES OF TI NON-SEWER TYPE SHALL CONFORM TO ANSI Z4.3. • PROVIDE TEMPORARY CONSTRUCTION OFFICE ON-SITE. · QUESTIONS, CALL CITY ENGINEER'S OFFICE

REQ'D SPECIAL INSPECTIONS

ORDINANCE NO. 1572 (EXTRACT) SEC. 5-305 REQUIRED INSPECTIONS. (A) REQUIRED INSPECTIONS INCLUDE, BUT ARE NOT LIMITED TO, THE FOLLOWING, BUT THE ABSENCE OF A PARTICULAR INSPECTION IN NO WAY RELIEVES THE CONTRACTOR FROM SECURING FOR OR PROVIDING

SUCH INSPECTIONS OR APPROPRIATE SUPERVISION. (B) BUILDING PERMIT 1. FOOTING OR FOUNDATION

2. CONCRETE SLAB OR UNDER-FLOOR 3. FRAMING - AFTER ELECTRICAL/PLUMBING/GAS/MECHANICAL ROUGH-IN 4. INSULATION (SEE ALSO ITEM (H)) 5. FIRE-RESISTANCE

AND IS IN FORCE AT THE TIME OF THE BUILDING PERMIT.

6. ROOFING a. SITE CLEAN-UP D. PROVIDED AND APPROVED PLANS WERE FOLLOWED c. EQUIPMENT, APPLIANCES, AND FIXTURES PROPERLY PLACED AND CONNECTED

d. CONSTRUCTION COMPLIES WITH BOARD OF ADJUSTMENT ISSUED VARIANCES

e. VERIFY OVERALL COMPLIANCE WITH THE APPROPRIATE BUILDING CODE AS ADOPTED BY THE CIT

(C) ELECTRICAL 1. METER LOOP 2. UNDERGROUND (IF NEEDED)

5. T.O.P.S. - TEMPORARY TO PERMANENT SERVICE

1. TEST NEW INSTALLATIONS (E) MECHANICAL

2. ROUGH-IN

3. TOP OUT

3. TEST AND BALANCE NEW INSTALLATIONS (F) PLUMBING (INCLUDES SEWER) 1. UNDERGROUND (IF NEEDED

5. BACKFLOW PREVENTION ASSEMBLY 6. TEST (HYDROSTATIC OR CODE-ALLOWED EQUIVALENT) a. NEW INSTALLATIONS

b. PARTS OF EXISTING INSTALLATION WHICH HAVE BEEN ALTERED, EXTENDED, RENOVATED, OR REPAIRED SHALL BE TESTED.

1. INSPECTIONS BY THE CITY FIRE INSPECTOR SHALL BE PER THE APPROPRIATE INTERNATIONAL FIRE CODE AND LIFE SAFETY CODE AT THE TIME OF INSPECTION. 1. INSULATION AND CORRECT R-VALUES (SEE ALSO ITEM (B)(4))

4. COMPLY WITH IECC DIRECTIVES (SEE ALSO ITEM (B)(4) **CONSTRUCTION OBSERVATION**

THE GENERAL CONTRACTOR IS REQUIRED TO CONTACT THE ARCHITECT FOR THE FOLLOWING CONSTRUCTION OBSERVATION SERVICES. AT LEAST 24 HOURS ADVANCE NOTICE MUST BE GIVEN FOR REQUIRED SITE VISITS

 REVIEW OF SHOP DRAWINGS, SAMPLES, AND SUBMITTALS • PREPARE CHANGES TO ARCHITECTURAL PLAN OR SPECIFICATIONS • VISIT CONSTRUCTION SITE APPROPRIATE TO STAGE OF CONSTRUCTION: PRIOR TO FOLINDATION POLIR

2. PROPER SGHC AND U VALUES FOR GLÀZING (SEE ALSO ÌTÈM (B)(4))

3. DESIGNED SEER FOR HVAC (SEE ALSO ITEM (B)(4))

- AFTER ERECTION OF STRUCTURAL SYSTEMS - AFTER MECHANICAL, ELECTRICAL, AND PLUMBING ROUGH-INS DURING INSTALLATION OF INSULATING MATERIALS, VAPOR BARRIERS AND ROOFING - AFTER APPLICATION OF INTERIOR-EXTERIOR FINISHES, AND INSTALLATION OF ROOFING - AFTER INSTALLATION OF INTERIOR FINISHES, CABINETRY, CEILINGS, MECHANICAL, ELECTRICAL, AND PLUMBING FIXTURES

- AFTER FINAL CLEANING (SUBSTANTIAL COMPLETION) - UPON RECEIPT OF NOTICE THAT CONSTRUCTION IS COMPLETE (FINAL) NOTIFYING CLIENT OF SUBSTANTIAL DEVIATION FROM THE PLANS **ELECTRICAL TRANSMISSION**

DISCLAIMER THE INFORMATION CONTAINED IN THE SIGNED AND SEALED DOCUMENTS IS DEEMED TO BE SUPERIOR TO ANY AND ALL ELECTRONIC INFORMATION. THE ELECTRONIC INFORMATION ORIGINATED IN THE OFFICES OF THORN+GRAVES PLLC IS CURRENT AS OF THE DATE OF ITS RELEASE, BUT THE USER ASSUMES RESPONSIBILITY FOR UPDATING THE INFORMATION TO REFLECT ANY CHANGES IN THE DESIGN FOLLOWING THE PREPARATION DATE OF THE TRANSFERRED INFORMATION, NOTHING IN THE TRANSFER OF ELECTRONIC DOCUMENTS SHOULD BE CONSTRUED TO PROVIDE ANY RIGHT OF THE CONTRACTOR OR OWNER OR OTHER RECIPIENT TO RELY ON THE INFORMATION PROVIDED BASED

IMPLIES THE REVIEW AND APPROVAL BY THE DESIGN PROFESSIONAL OF ANY DRAWING. THERE IS NO REPRESENTATION OF THE SUITABILITY OF THE ELECTRONIC INFORMATION FOR OTHER PURPOSES, OF THE DURABILITY OF THE INFORMATION OR THE MEDIUM THROUGH WHICH THE INFORMATION IS FURNISHED. ANY USE FOR A PURPOSE OTHER THAN THAT FOR WHICH THE INFORMATION IS INTENDED SHALL BE AT THE RECEIVER'S RISK AND THEREFORE THE RECEIVER SHALL

PRINCIPALLY ON THE ELECTRONIC INFORMATION: NOR THAT THE USE OF ELECTRONIC INFORMATION

TRANSFER OF ELECTRONIC INFORMATION DOES NOT TRANSFER ANY LICENSE TO USE THE UNDERLYING SOFTWARE OR EXTINGUISH THE RIGHTS OF THE SENDER TO REUSE THE INFORMATION IN THE GENERAL COURSE OF A PROFESSIONAL PRACTICE. THIS ELECTRONIC INFORMATION IS A COMPONENT OF THE INSTRUMENTS OF SERVICE AND IS ONLY FOR THE CLIENT'S BENEFIT ON THIS

FOR SUBJECT FACILITIES, CONFORMANCE WITH THE TEXAS ACCESSIBILITY STANDARDS (TAS) IS REQUIRED BY THE TEXAS ARCHITECTURAL BARRIERS ACT (ARTICL 9102, TEXAS CIVIL STATUTES).

CONTRACTOR SHALL KEEP A COMPU OF THE CURRENT TEXAS ACCESSIBILITY STANDARDS AND ALL TECHNICAL MEMORANDUMS ON SITE FOR REFERENCE PURPOSES THROUGHOUT CONSTRUCTION.

COPIES OF THE TEXAS ACCESSIBILITY STANDARDS AND TECHNICAL MEMORANDUMS MAY BE DOWNLOADED/ORDERED FROM THE TEXAS DEPARTMENT OF LICENSING AND REGULATION VIA THE FOLLOWING METHODS:

APPLICABLE PROJECT DESIGN PROFESSIONAL. IT IS THE RESPONSIBILITY OF THE CONTRACTOR AFTER FINAL TAS INSPECTION AT THE COMPLETION OF THE PROJECT TO PROVIDE FOR ANY CORRECTIVE ACTIONS FOR ANY CITED ITEMS.

PROTECT AND INDEMNIFY THE SENDER FROM CLAIMS, LOSSES, COSTS, OR DAMAGES.

B) INTERNET ORDER: http://www.license.state.tx.us/ab/forms/AB040.pdf

C) PDF DOWNLOAD: http://www.license.state.tx.us/ab/abtas.htm

CODE ANALYSIS

O THE BEST KNOWLEDGE OF THE ARCHITECT AND CONSULTANTS ENGINEERS, THE DRAWINGS AND SPECIFICATIONS MEET THE FOLLOWING: THE DESIGN IS IN ACCORDANCE WITH THE CITY OF SAN ANTONIO, TEXAS' UDC AND ADOPTED CODES, ZONING ORDINANCE AND LOCAL AMENDMENTS: 2018 EDITIONS OF THE INTERNATIONAL CODES, AS THEY MAY BE AMENDED BY THE CITY OF SAN ANTONIO, LS1.1

SUMMARY OF CODE ANALYSIS
PROPOSED SCOPE OF WORK IS FOR RENOVATION FOR 5945 BROADWAY CODE ANALYSIS WAS PERFORMED FOR B OCCUPANCY

CITY OF SAN ANTONIO, BEXAR COUNTY, TEXAS,

SITE ADDRESS: 5945 BROADWAY, SAN ANTONIO, TX 78209 ZONING CLASS:_ <u>CALCULATIONS</u> USE AND OCCUPANCY CLASSIFICATION: B (IBC 2015).

CONSTRUCTION TYPE: TYPE VB

OCCUPANT LOAD (IBC 2018, TABLE 1004.1.2) CALCULATED TOTAL = 12 ACCESSORY (300 GR--OSS) 605.4 SF

MINIMUM NUMBER OF EXITS REQUIRED (1005 & 1021): SHALL NOT BE LESS THAN TOTAL OCCUPANT LOAD SERVED BY MEANS OF EGRESS MULTIPLIED BY 0.3 IN. PER OCCUPANT FOR STAIRWAYS AND BY 0.2 IN. PER OCCUPANT FOR OTHER EGRESS COMPONENTS. $12 \times 0.2 = 2.4$ IN. REQUIRED EGRESS WIDTH / 96 IN. TOTAL EGRESS PLUMBING SUSTEMS (2902.1)

WC REQUIRED = 1 / 1 PROVIDED LAV. REQUIRED = 1 / 1 PROVIDED FIXTURES: DRINKING FOUNTAIN: 1 PER 100 = 1 REQUIRED / 0 PROVIDED (COMBO HI/LO ADA UNIT) BOTTLED WATER AVAILABLE ON REQUEST


SERVICE SINK = 1 REQUIRED / PROVIDED PARKING
EXISTING PARKING: 6 TOTAL SPACES (1 ACCESSIBLE SPACE).

1595.9 SF BLDG / (300 GROSS SF BUILDING / 1 PARKING SPACE) = 6 PARKING SPACES <u>CEILING HEIGHTS</u>
*BULKHEADS ARE NO LESS THAN 7'-0", AS REQUIRED, REFER TO SECTIONS.

THERE ARE NO BARS, GRILLES, OR GRATES SCHEDULED TO BE INSTALLED OVER THE *PANIC HARDWARE STD. INSTALL FOR DOORS AS INDICATED ON PLAN - REFER TO HARDWARE SCHEDULE. <u>ELECTRICAL</u>
*ALL OUTLETS IN FOOD PREPARATION AREAS AND BATHROOMS WILL BE GROUND

FAULT CIRCUIT INTERRUPTION RATED AND LABELED. *THE ABOVE CODE SUMMARY FORMAT IS COPYRIGHT 2014 BY THORN + GRAVES ARCHITECTS. REPRODUCTION OF THIS FORMAT REQUIRES ADVANCE WRITTEN AUTHORIZATION FROM THORN + GRAVES ARCHITECTS.

LOCATION MAP

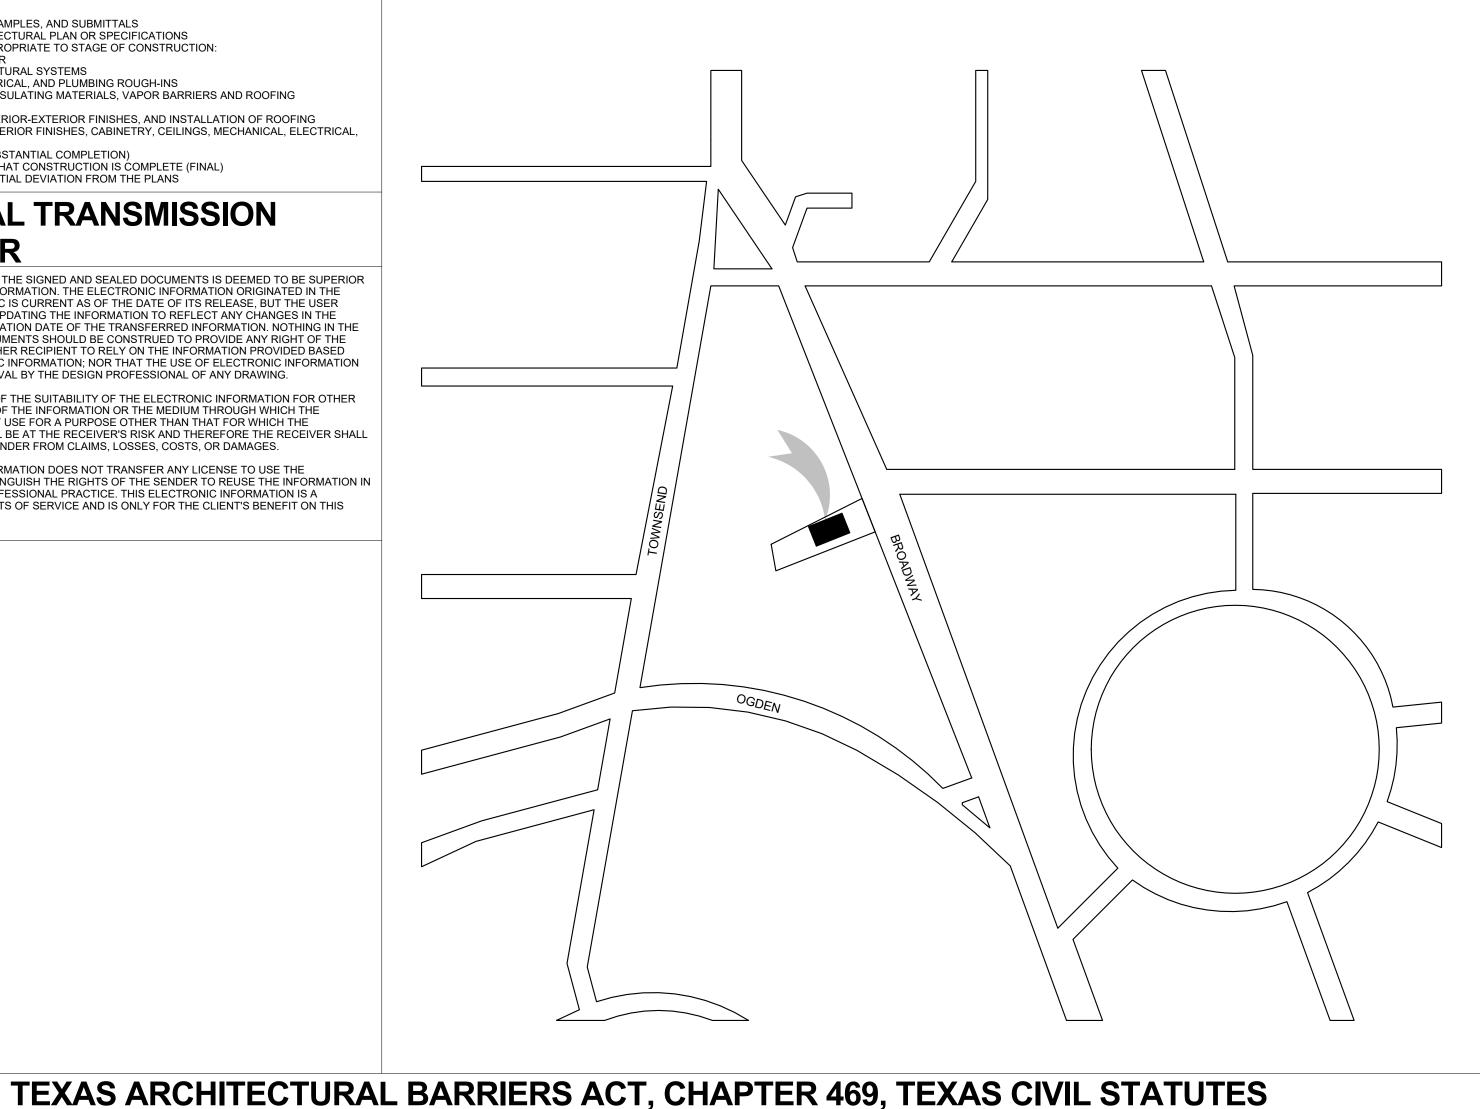

IFE SAFETY LEGEND ROOM NAME H# ROOM NUMBER OCCUPANCY TYPE B ### SF ROOM SF SF PER PERSON - ### SF = ### - OCCUPANCY LOAD EGRESS PATH FIRE EXTINGUISHER CABINET PARTITION KEY - REF. INTERIOR WALL TYPES 1/LS1.1 Egress Path Distance Length 34' - 11 1/2" 34' - 4" 31' - 10" 41' - 3 3/4" 40' - 3 7/32" 32' - 1 7/32" 18' - 3 27/32"

SHOWROOM 2 STORAGE 6 B 736 SF S | 172 SF

ABBREVIATIONS

ALTERNATING CURRENT ADD'N BASEMENT CUBIC FEET PER MINUTE CKT.

48' - 1 1/4"

28' - 6"

GROUND CONTRACTOR SHALL OBTAIN A COPY OF THE PROJECT TEXAS ACCESSIBILITY STANDARDS (TAS) PLAN REVIEW MAY BE INTERIOR REQUESTED FROM THE PROJECT DESIGN PROFESSIONAL OR OWNER. CONTRACTOR SHALL REVIEW THE TAS PLAN REVIEW LETTER AND ACCOMPANYING REPORT. IF NON-CONFORMING ELEMENTS PROPOSED ON PLANS ARE CITED, CONTRACTOR SHALL COORDINATE CORRECTIVE ACTION WITH THE POUND MEZZANINE PUSH BUTTON

STRUCT'L

wwm.

SPECIFICATION(S)

WELDED WIRE MESH, W.W.F.

STRUCTURAL THERMOSTAT

THICK(NESS)

UNDERSIDE

VENTII ATION

WASTE LINE

DOORSTOP MANUFACTURED PRFFAB PREFABRICATED PRESS PAINTED

STORY

VERTICAL

TOPO.

VERT.

FLOOR HOSE BIB HOT WATER ON CENTER PRESSURE QUARRY TILF REGISTER REINFORCE(MENT/ING) REQUIRED SEWER LINE SCHED. SCHEDULE(D)

TONGUE AND GROOVE

TOPOGRAPHY(ICAL)

WEI DED WIRE FABRIC

LEVEL 1 - LIFE SAFETY PLAN

BUILT-UP ROOF CURB & GUTTER CONCRETE MASONRY UNIT COLUMN CONSTRUCTION DOUBLE HUNG ELEVATION (HEIGHT) ELEV. FLUORESCENT F.P.M. FEET PER MINUTE GYPSUM WALLBOARD HOLLOW METAL INTERIOR DIAMETER KITCHEN MECHANICAL MEMB. MANUFACTURER MINIMUM MASONRY OPENING N OPPOSITE PROPERTY LINE PI AM PLASTIC LAMINATE PROJECT PROPOSED

RISFR

REVISION

SHOWER

SYMBOL

TYPICAL

VINYL TILE

STANDARD

TELEPHONE

VARIABLE/VARIES

RADIUS

RETURN

SEWER

STAGGERED

SUSPENDED

TRANSOM

VAPOR

VOLUME

TO BE DETERMINED

SEW. STAG.

VOL.

STAINLESS STEE

VFRIFY IN FIELD

SUPPLY

TREAD

V.I.F.

TANGEN

VACUUM

WITHOUT

ELEVATION (FACADE) **EMERGENCY** GLASS/TEMPEREI HORIZONTAL HORSEPOWER INCLUDE(ING) INSULATION LAMINATÈ LAVATORY NOT IN CONTRACT NORTH OVERHEAD DOOR PLASTER PLYWOOD POUNDS PER SQUARE INCH REFER(ENCE) ROUGH

TEMP

UNGR. VCT

CEMENT(ITIOUS)

CAULKING

COMMON

DIAGONAL

SHEET STEEL

TEMPERATURE UNDER GROUND

VINYL WALL COVER(INC

COLD WATER

ORAGE 4

TORAGE 5

VINYL COMPOSITION TIL

This document © 2016 "THORN GRAVES" Reproduction in whole of part without written authorization of THORN GRAVES ARCHITECTS is prohibited.

V.T.R.

Щ Х

REVISIONS / DATE

PROJECT NO.: Author Project Number CHECKED: Checker 11/25/19 As indicated

DRAWING TITLE: **COVER SHEET**

SHEET NO.:

WATER HEATER WATER CLOSET

VENT THROUGH ROOF V.W.C.


SINGLE HUNG

STORAGE

SYSTEM TECHNICAL


UNFINISH(FD)

VAPOR BARRIER

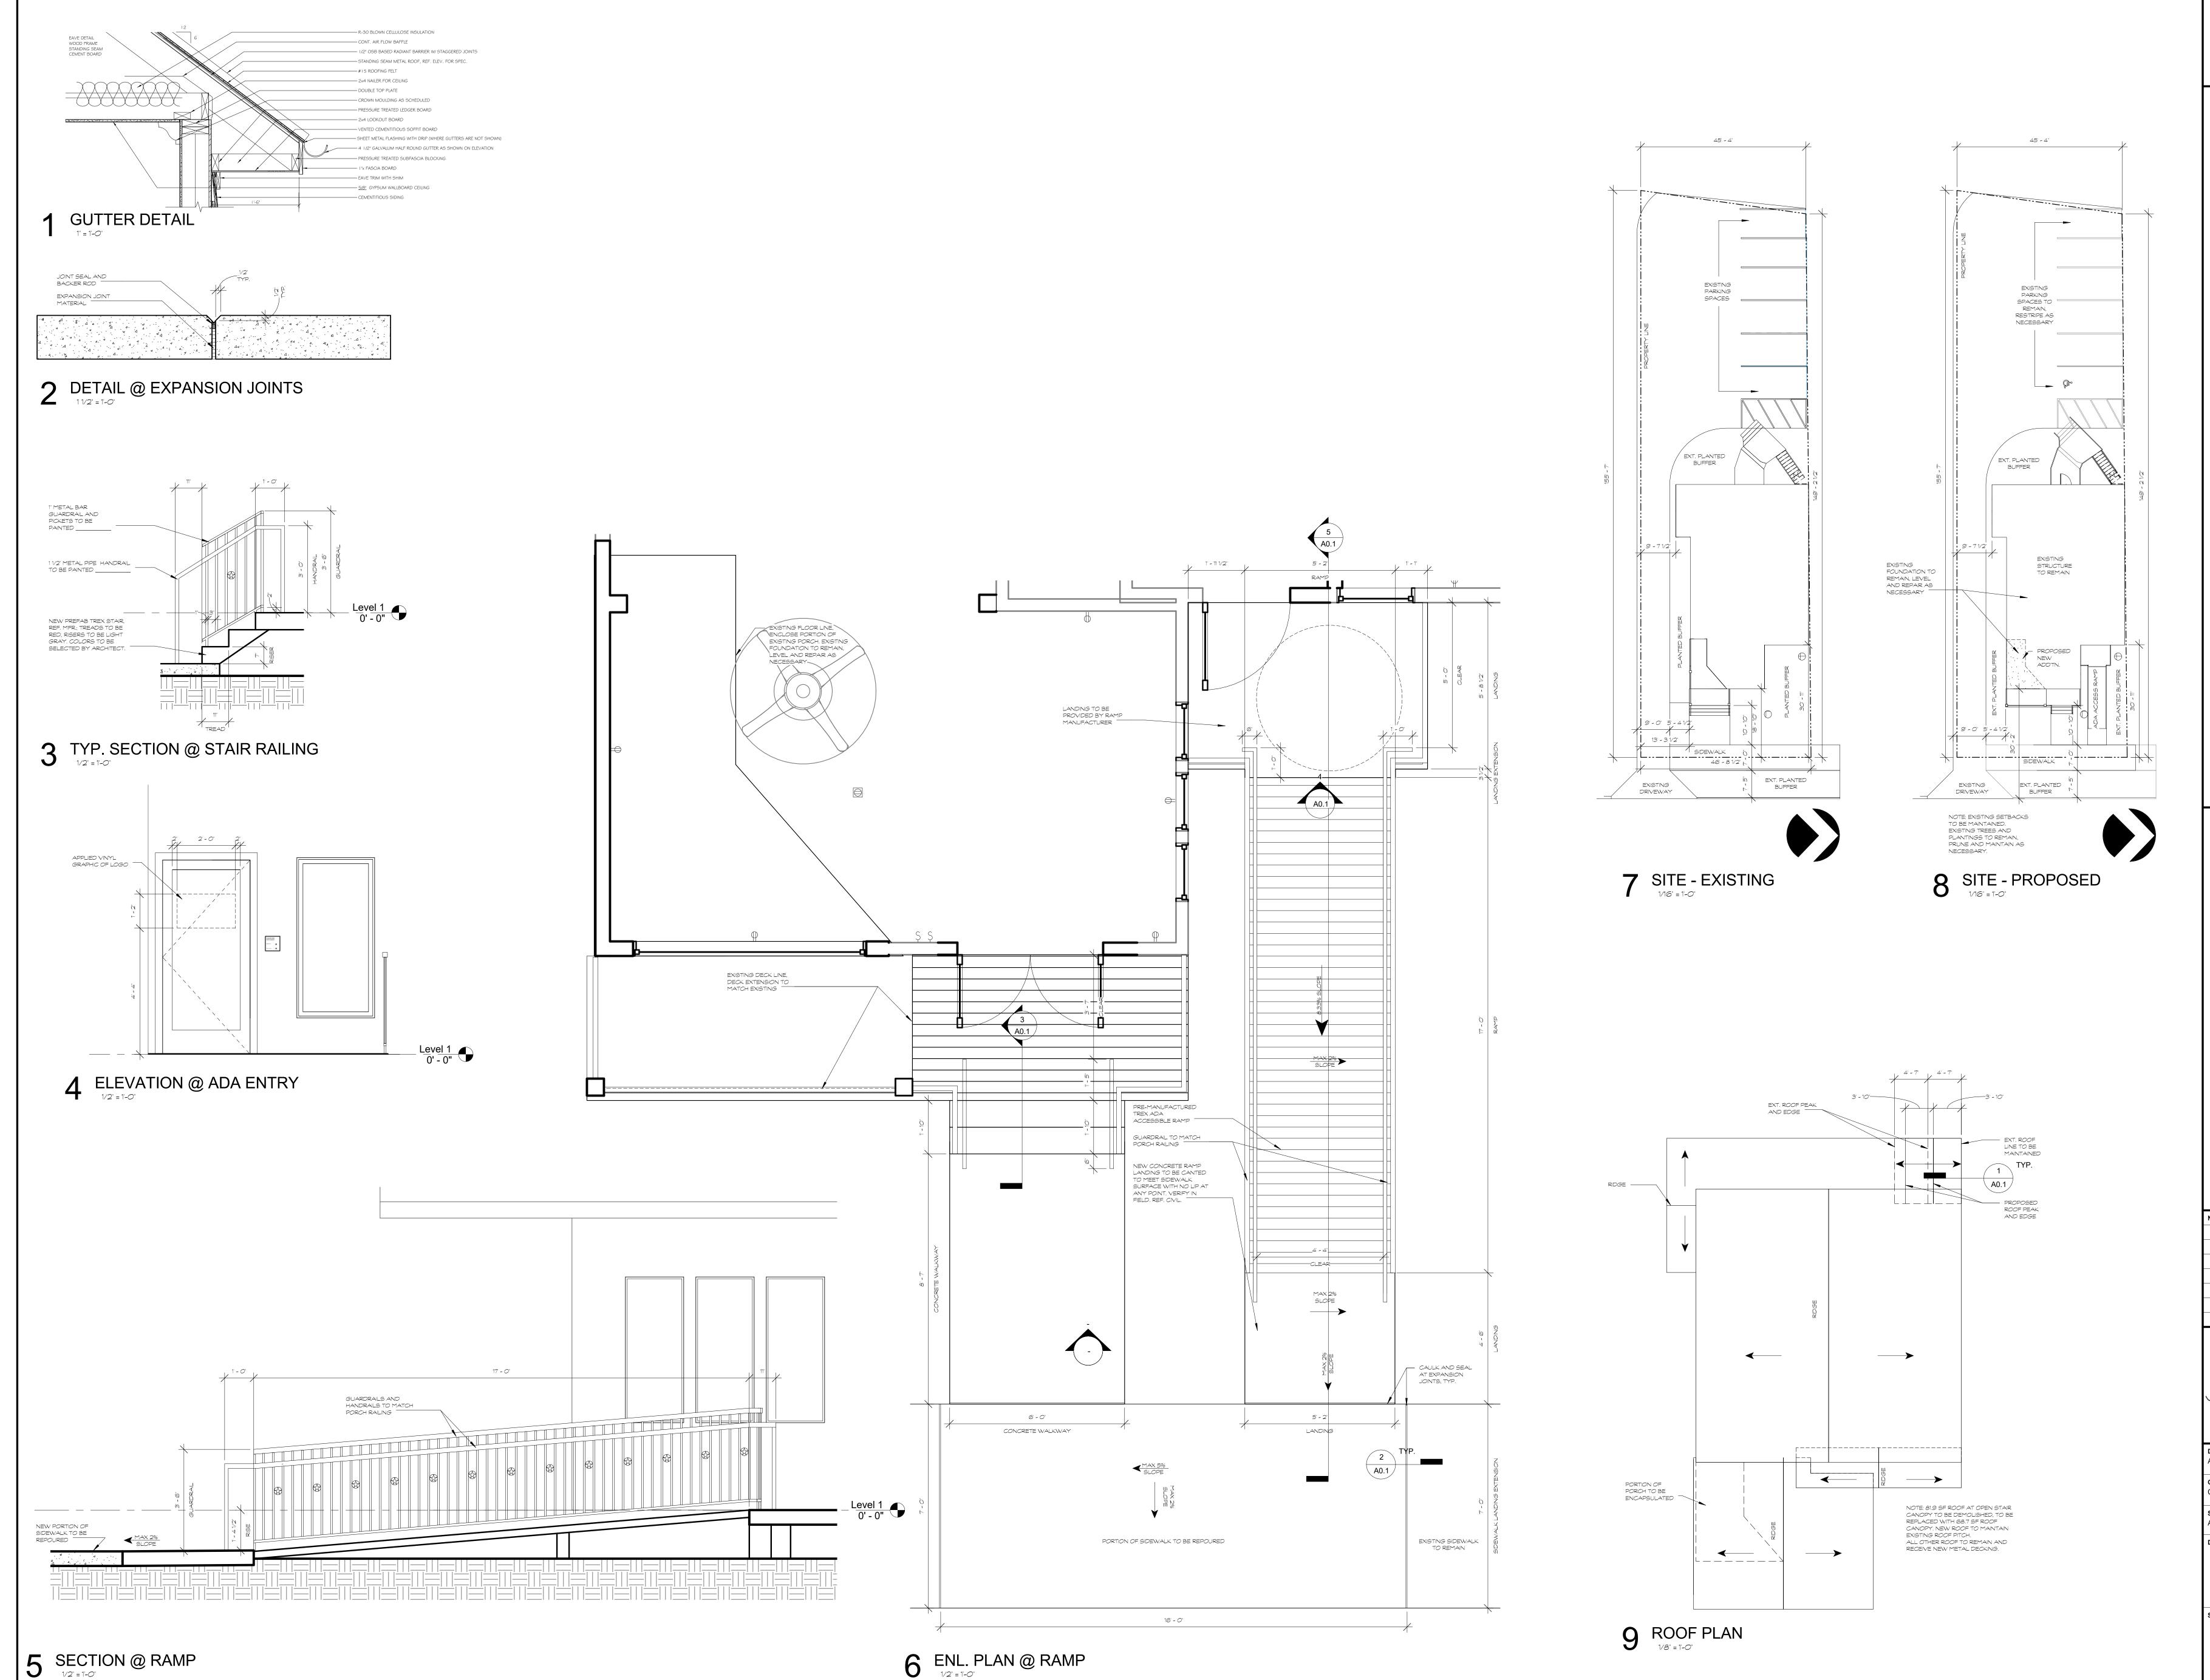

BARREN

REVISIONS / DATE

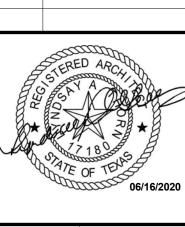

PROJECT NO.: Author Project Number CHECKED: 11/25/19 Checker SCALE: As indicated DRAWING TITLE: SITE PLAN & SITE

DETAILS

SHEET NO.:

This document © 2018 THORN GRAVES ARCHITECTS: Reproduction in whole or part without written authorization of THORN GRAVES ARCHITECTS is prohibited.

PROJECT NO.: Author Project Number CHECKED: DATE: 11/25/19 SCALE: As indicated

DRAWING TITLE: **EXTERIOR ELEVATIONS**


SHEET NO.:

A3.1

This document © 2018 THORN GRAVES ARCHITECTS: Reproduction in whole or part without written authorization of THORN GRAVES ARCHITECTS is prohibited.

NEW GLAZED ADA ACCESS DOOR

Level 1 0' - 0"

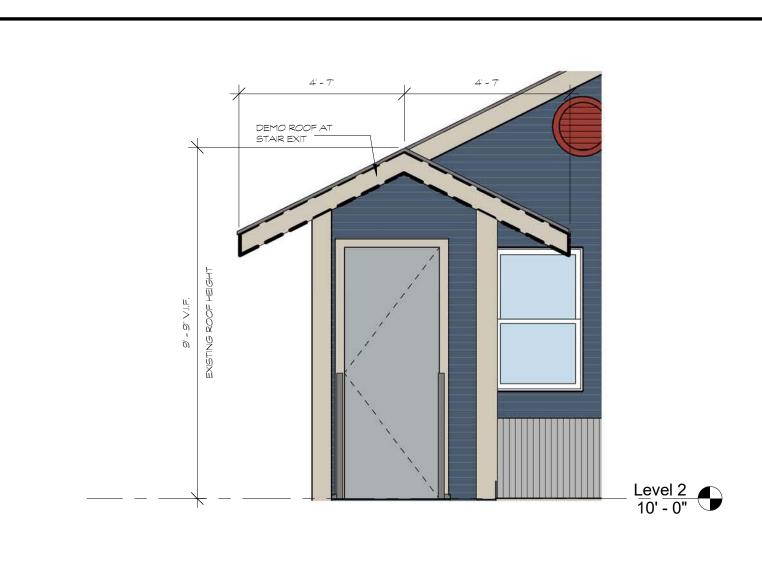

5 WEST - PORTICO ROOF DEMO





4 NORTH - PROPOSED

3 WEST - Proposed

ROOF PITCH TO
REMAIN AS EXISTING,
TYP. ROOF TO RECEIVE
NEW METAL DECKING

NOTE: WINDOWS TO BE REPLACED IN EXISTING POSITIONS TO MATCH EXISTING



2 SOUTH - PROPOSED

EAST - PROPOSED

PICTOGRAMS SHALL HAVE A FIELD HEIGHT OF 6 INCHES MINIMUM. CHARACTER AND BRAILLE SHALL NOT BE LOCATED IN THE PICTOGRAM FIELD. BOTH VISUAL AND TACTILE CHARACTERS ARE REQUIRED. RAISED CHARACTERS SHALL BE DUPLICATED IN BRAILLE. RAISED CHARACTERS SHALL BE 1/32 IN. MIN, ABOVE BACKGROUND. CHARACTERS SHALL BE SANS SERIF. TACTILE CHARACTES ON SIGNS SHALL BE LOCATED 48" MIN.
A.F.F. MEASURED FROM THE BASELINE OF THE LOWEST TACTILE CHARACTER AND 60" MAX A.F.F. OR GROUND SURFACE MEASURED FROM THE BASELINE OF THE HIGHEST TACTILE CHARACTER. CHARACTERS AND BRAILLE SHALL NOT BE LOCATED IN THE PICTOGRAM FIELD.

SIGNS SHALL BE LOCATED ALONGSIDE THE DOOR AT THE LATCH SIDE. CHARACTERS AND THEIR BACKGROUND SHALL HAVE A NON-GLARE FINISH. CHARACTERS SHALL CONTRAST WITH THEIR BACKGROUND WITH EITHER LIGHT ON DARK OR DARK ON LIGHT. CHARACTERS MAY BE ANY CASE.
CHARACTERS SHALL BE CONVENTIONAL IN FORM. CHARACTERS SHALL NOT BE ITALLIC, OBLIQUE, SCRIPT, HIGHLY DECORATIVE, OR OF UNUSUAL FORMS. REFER TO 2012 TEXAS ACCESSIBILITY STANDARDS, CHAPTER 7,

SUBCHAPTER 703 ISGNS FOR ADDITIONAL SPECIFIC INFORMATION AND COMPLIANCE.

RESTROOMS MUST BE IDENTIFED ACCORDING TO GENDER WITH 8" SYMBOLS CENTERD 60" A.F.F. SYMBOLS MUST BE RAISED AT LEAST 1/4" FROM WALL SURFACE FOR PURPOSE OF CLARITY. IT IS RECOMMENDED THAT WORD SIGNS ALSO BE PROVIDED.


- CHARACTER HEIGHT = 5/8"
- CHARACTER WIDTH = 3/8" 5/8"


STROKE WIDHT = 1/6" 1/8"

PICTOGRAM BORDER HEIGHT = 6" MIN. CHARACTERS RAISED 1/32"

GRADE 2 BRAILLE POSITIONED BELOW TEXT LOCATION: ON WALL ADJACENT TO LATCH SIDE OF DOOR CENTERD 60" A.F.F.

ACCESSIBILITY SYMBOL SIGNAGE TO BE PLACED PER TAS FOR ALL RESTROOMS IDENTIFIED AS ACCESSIBLE.

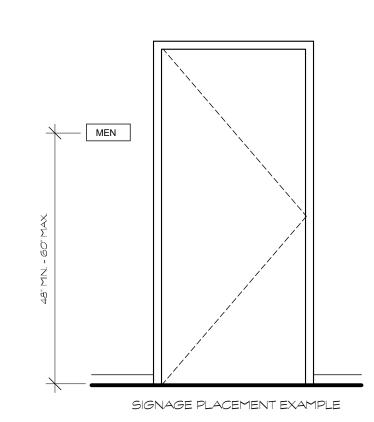


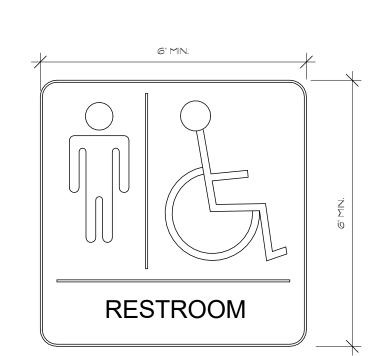



TOILET	ACCESSORIES SC	HEDULE		
MARK	DESCRIPTION	MANUFACTURER	COMMENTS	MOUNTING HT.
TA-1	GRAB BARS - (1) 42" AND (1) 36" S.S.	BOBRICK	36" AFF TO CENTERLINE	36" AFF TO CENTERLINE
TA-2	HAND SOAP DISPENSER	BOBRICK	48" MAX AFF TO CENTER OF DISPENSER	48" MAX AFF TO CENTER OF DISPENSER
TA-3	TOILET PAPER DISPENSER - SINGLE	BOBRICK	14" TO 19" FROM AFF TO BOTTOM OF DISPENSER	14" TO 19" FROM AFF TO BOTTOM OF DISPENSER
TA-4	PAPER TOWEL DISPENSER	BOBRICK	4'-4 3/4" FROM AFF TO TOP OF PAPER TOWEL DISPENSER	4'-4 3/4" FROM AFF TO TOP OF PAPER TOWEL DISPENSER
TA-5	MIRROR WITH S.S. FRAME	BOBRICK	40" AFF TO BOTTOM OF REFLECT. SURFACE	40" AFF TO BOTTOM OF REFLECT. SURFACE

DESCRIPTION	MOUNTING HEIGHT	REMARK	
WATER CLOSET HC ADULT	1-5" TO TOP OF SEAT	FLOOR OR WALL	
WALL HUNG LAVATORY HC	2'-10" TO RIM	2-5' MIN. CLEAR UNDER APRON	
LAVATORY COUNTERS	2'-10" TO TOP	2'-5" MIN. CLEAR UNDER APRON	
EXTINGUISHER CABINETS	4'-6" TO TOP OF EXT. CAB.		
STAIR HANDRAILS	3'-0" ABOVE NOSING	ABOVE NOSING AT STAIRS	
GUARDRAILS	3'-6' TO TOP	2'-5" MIN. CLEAR UNDER APRON	
SWITCHES	4'-0" TO CENTER		
WALL TELEPHONE OUTLETS	4'-0" TO CENTER		
RECEPTACLES/PHONE OUTLETS	NO LESS THAN 1-3" A.F.F.		
ABOVE COUNTER OUTLETS	6" ABOVE COUNTER	OUTLETS MOUNTED HORIZ.	
THERMOSTATS	4-0" TO CENTER	AT OPERABLE TYPE	

ALL HARDWARE, PILASTERS, SHOES, SLEEVES, DOOR PULLS, COAT HOOK, HINGES, AS PER PLASTIC PART. MANUFACTURER STANDARDS, AND TO

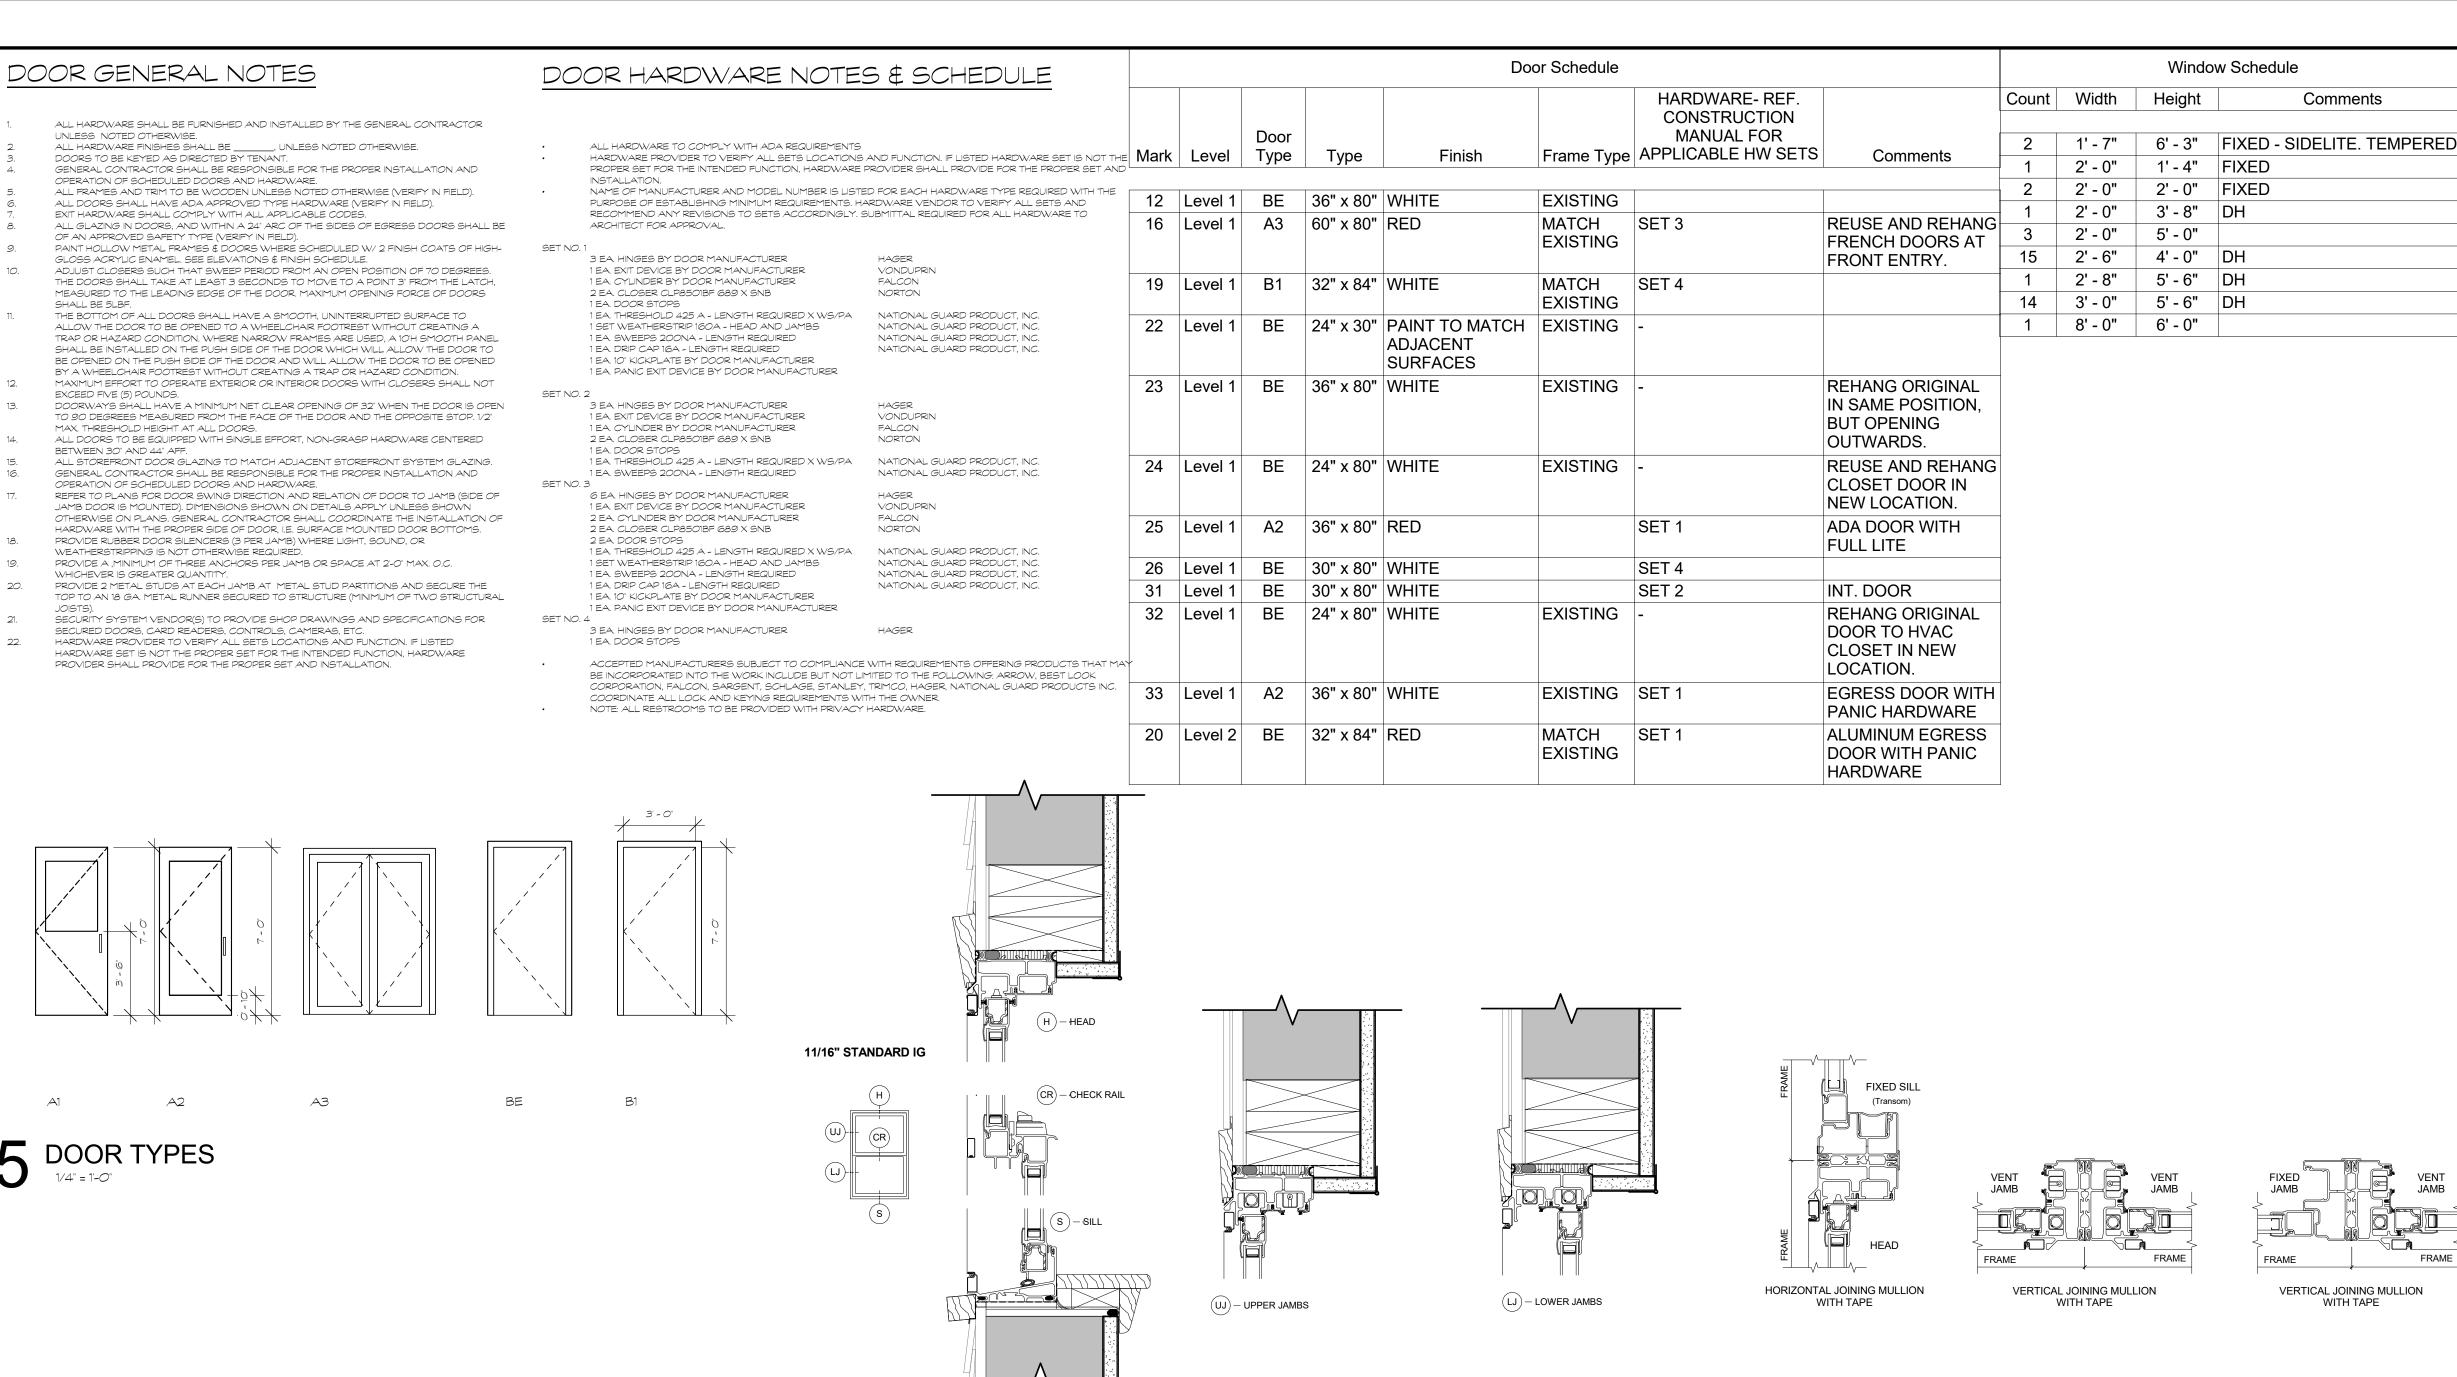

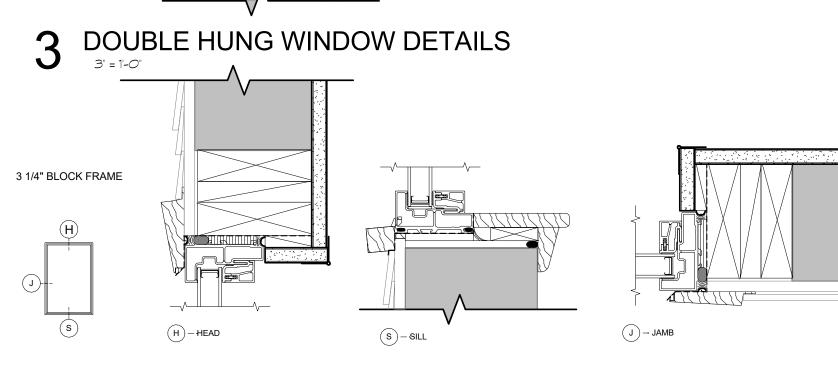


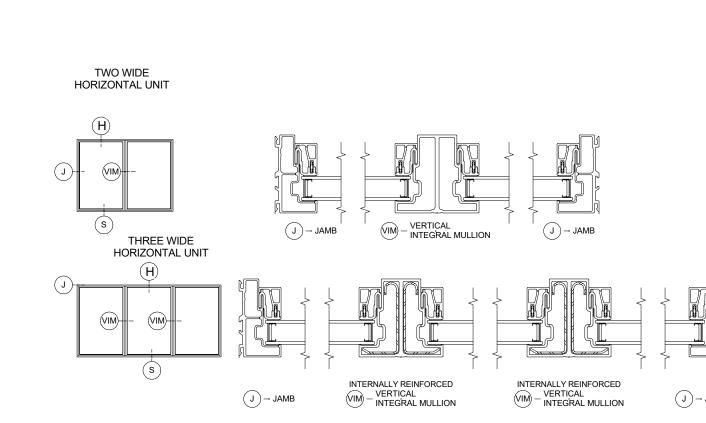

Window Schedule

Comments



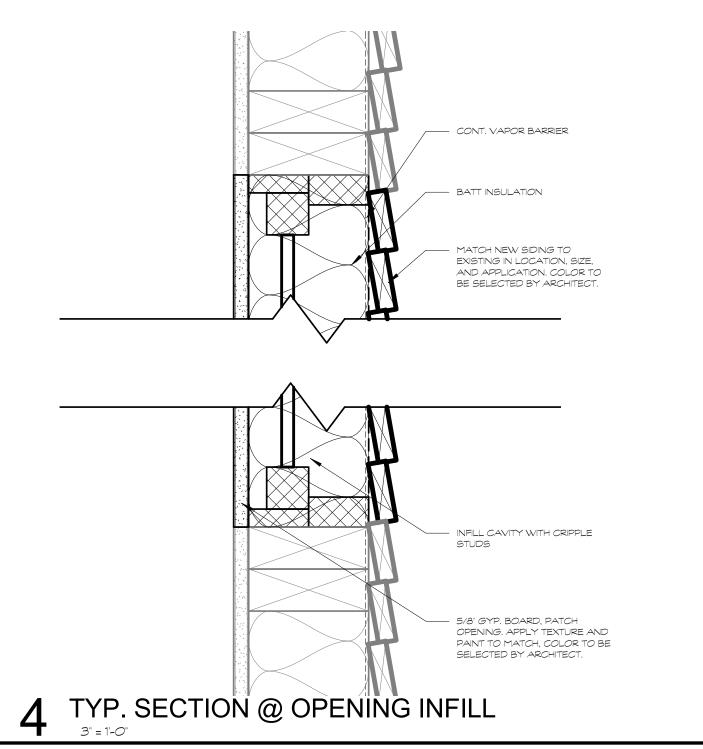

REVISIONS / DATE

78

Щ W

VERTICAL JOINING MULLION

WITH TAPE

PROJECT NO.: Author Project Number CHECKED: Checker SCALE:

As indicated DRAWING TITLE: **DOOR & WINDOW**

SCHEDULE

This document © 2018 THORN GRAVESARCHITECTS: Reproduction in whole or part without written authorization of THORN GRAVESARCHITECTS is prohibited.