

# CITY OF ALAMO HEIGHTS COMMUNITY DEVELOPMENT SERVICES DEPARTMENT 6116 BROADWAY SAN ANTONIO, TX 78209 210-826-0516

## Board of Adjustment Meeting Wednesday, September 06, 2023 – 5:30 P.M.

Take notice that a regular meeting of the Board of Adjustment of the City of Alamo Heights will be held on **Wednesday**, **September 06**, **2023**, **at 5:30pm** in the City Council Chambers, located at 6116 Broadway St, San Antonio, Texas, 78209, to consider and act upon any lawful subjects which may come before it.

INSTRUCTIONS FOR TELECONFERENCE: The City will make reasonable efforts to allow members of the public to participate via audio by dialing 1-346-248-7799 and enter access number 893 9488 9735#. If you would like to speak on a particular item, when the item is considered, press \*9 to "raise your hand". Citizens will have three (3) minutes to share their comments. The meeting will be recorded.

The City cannot guarantee participation by phone due to unforeseen technical difficulties or provide prior notice if they occur; therefore, the City urges your in-person attendance if you require participation.

## **Case No. 2395 – 6411 Broadway St**

Application of NBD 6401 LP, owner, requesting the following variance(s) in order to construct a new commercial use building at the property located at **CB 4024**, **BLK 165**, **LOT 18**, also known as **6411 Broadway St**, zoned B-1:

1. The proposed overall height of 23ft 8-inches does not meet the minimum 28ft height required for properties with frontage along Broadway St and Austin Hwy per Section 3-68(2) of the City's Zoning Code.

Plans may be viewed online\* (<a href="www.alamoheightstx.gov/departments/planning-and-development-services/public-notices">www.alamoheightstx.gov/departments/planning-and-development-services/public-notices</a>) and at the Community Development Services Department located at 6116 Broadway St. You may also contact Michelle Ramos, Planner (<a href="marmos@alamoheightstx.gov">marmos@alamoheightstx.gov</a>) or Lety Hernandez, Director, (<a href="marmos@alamoheightstx.gov">lhernandez@alamoheightstx.gov</a>) by email or our office at (210) 826-0516 for additional information regarding this case. Please note floor plans will not be available online.

1

08/23/2023

City of Alamo Heights Board of Adjustment Community Development Services 6116 Broadway San Antonio, TX 78209

Permit Number 2023-144

Job address: 6411 Broadway, Alamo Heights, TX 78209

To Whom It May Concern,

We formally request a variance for the building height of Alamo Heights Commercial (Permit Number 2023-144), a new commercial construction on 6411 Broadway on the 6400 Block of Broadway Lot 9, in relation to the City of Alamo Heights Code of Ordinances Section 3-68(2):

Section 3-68(2): For properties with frontage along Broadway and Austin Hwy. all main structures shall have a minimum height of twenty-eight (28) feet.

The height of the proposed building is 22'-6" to parapet (16'-8" as measured according to definition of "Height" under Section 3-2). We request a variance for the height for the following reasons:

- 1. The building was reviewed and approved by the City of Alamo Heights Architecture Review Board on December 22, 2022 and the City Council on January 09, 2023. The design, including the building height, was deemed appropriate in relation to its site context, taking into consideration the two items listed below.
- 2. The building was designed with consideration of its location, situated in between two existing buildings at 6401/6403 Broadway and 6421 Broadway on a continuous block. The existing buildings are single story buildings with heights no higher than 15'-0". The design intent of the new construction is to create connectivity and cohesion among the three buildings, as illustrated in the rendering on the cover page of the Construction Document set (see G0.0). A building that is 28'-0" or taller risks disrupting the connectivity and towering over the existing adjacent buildings, and would also cast a large shadow over the pedestrian pathways in between the buildings.



3. The site has a grade change of approximately 10'-13' over the distance of 150'-0" from its eastern property line on Broadway to the edge of its western property line that touches the residential properties (see C1.0, C3.0). Taking into consideration both the distance and the downward slope from Broadway to the residential properties, we argue that there is not a significant difference between the coverage provided by a 22'-6"-tall building versus a 28'-tall building.

Please refer to the attached documents listed below for detailed information on the site and the proposed new construction.

## Attached Documents

- BOA Project Review Application
- Calculations of impervious coverage and lot coverage to floor area ratio
- Photographs of existing structure
- Construction Document drawings resized to 11"x17" and to scale. The required submittal material can be found in the following drawings:
  - Tree survey (C1.0)
  - Existing site plan and survey (C1.0)
  - Proposed site plan (C2.0)
  - Floor plans and elevations (A1.1-A2.2)

If you have any questions or if you need additional information, please reach me at 917 294 2521 or troy@schaumshieh.com

Troy Schaum SCHAUM/SHIEH



## LOT COVERAGE AND FAR CALCULATIONS

LOT COVERAGE	EXISTING CALC. (SF)	PROPOSED CALC. (SF)
LOT AREA	+/- 42,000 SF	+/- 42,000 SF
6411 BROADWAY BUILDING FOOTPRINT (NEW)	0	+ / - 4,278 SF <sup>1</sup>
6421 BROADWAY BUILDING FOOTPRINT (EXISTING)	+/- 1,300 SF	+/- 1,300 SF
6401/6403 BROADWAY BUILDING FOOTPRINT (EXISTING)	+/- 6,650 SF	+/- 6,650 SF
TOTAL LOT COVERAGE	+/- 7,950 SF	+/- 12,228 SF
LOT OF COVERAGE (TOTAL LOT COVERAGE / LOT AREA)	0.19	0.29
FLOOR AREA RATIO (FAR)		
LOT AREA	+ / - 42,000 SF	+ / - 42,000 SF
6411 BROADWAY 1 FLOOR (NEW)	0	+ / - 4,278 SF <sup>1</sup>
6421 BROADWAY 1 FLOOR (EXISTING)	+/- 1,300 SF	+/- 1,300 SF
6401/6403 BROADWAY 1 FLOOR (EXISTING)	+/- 6,650 SF	+/- 6,650 SF
TOTAL FLOOR AREA	+/- 7,950 SF	12,228 SF
TOTAL FAR (TOTAL FLOOR AREA / LOT AREA)	0.19	0.29
TOTAL IMPERVIOUS COVER		
FOOTPRINT OF ALL STRUCTURES	7,950 SF	12,228 SF
DRIVEWAY/PARKING PAD	17,858 SF	16,137 SF
WALKWAYS	3,293 SF	7,389 SF
OTHER IMPERVIOUS COVER	786 SF	759 SF
TOTAL IMPERVIOUS COVER	29,887 SF	36,257 SF
HEIGHT OF MAIN STRUCTURE		
6411 BROADWAY (NEW)	0	22'-6"2
6421 BROADWAY (EXISTING)	14'-4"	14'-4"
6401/6403 BROADWAY (EXISTING)	14'-0"	14'-0"

<sup>1. 257</sup> SF of patio, building footprint 4.021 SF

<sup>2. 22&#</sup>x27;-6" to top of parapet, 16'-8" to top of roofing membrane



## **Photographs of Existing Structures**















**ALAMO HEIGHTS COMMERCIAL** 

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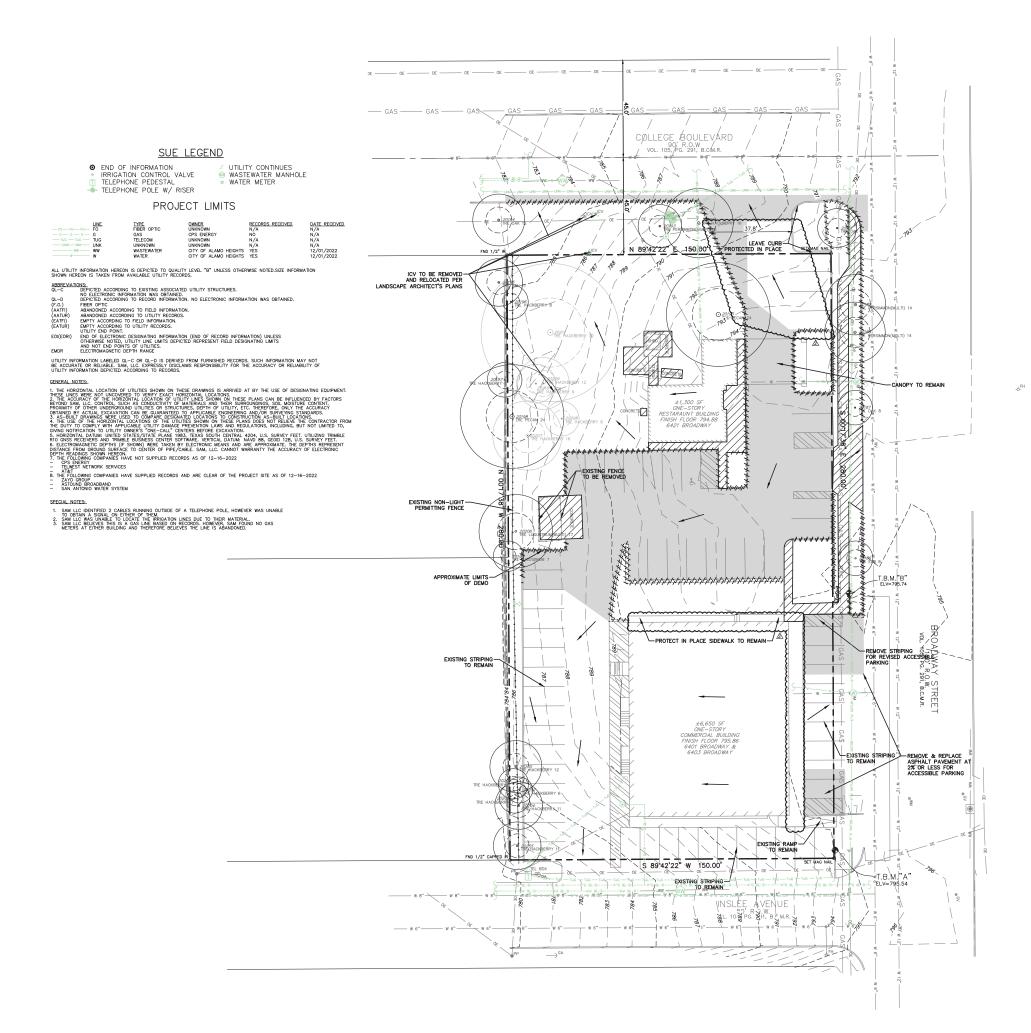
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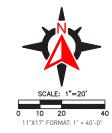
6401 Broadway Alamo Heights, TX 78209



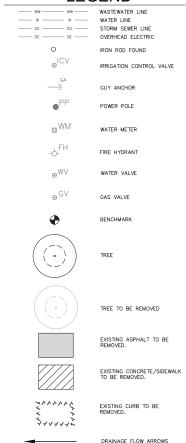
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## **LEGEND**



SURVEY WAS PERFORMED BY WINDROSE SURVEYING & LAND SERVICES, LLC. CONTACT COREY CAMPBELL AT (210)634-1565 FOR ANY

## SITE INFO

## LEGAL DESCRIPTION

BEING A TOTAL OF 0.9642 OF AN ACRE, ALL OF LOT 18, BLOCK 165, BROADWAY CENTRAL SUBDIVISION, CITY OF ALAMO HEIGHTS RECORDED IN VOLUME \_\_\_\_ PAGE \_\_\_ OF THE DEED AND PLAT RECORDS OF BEXAR COUNTY, TEXAS.

### **FLOOD INFORMATION**

PROJECT IS LOCATED OUTSIDE REGULATORY FLOOD ZONES BASED ON FEMA FIRM 48029C0402H DATED 06/19/2020.

### BENCHMARK INFORMATION

T.B.M. "A" N: 13724792.61 E: 2138184.38 ELEVATION: 795.54

> T.B.M. "B" N: 13724911.51 E: 2138191.09 ELEVATION: 795.74

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PROJECT

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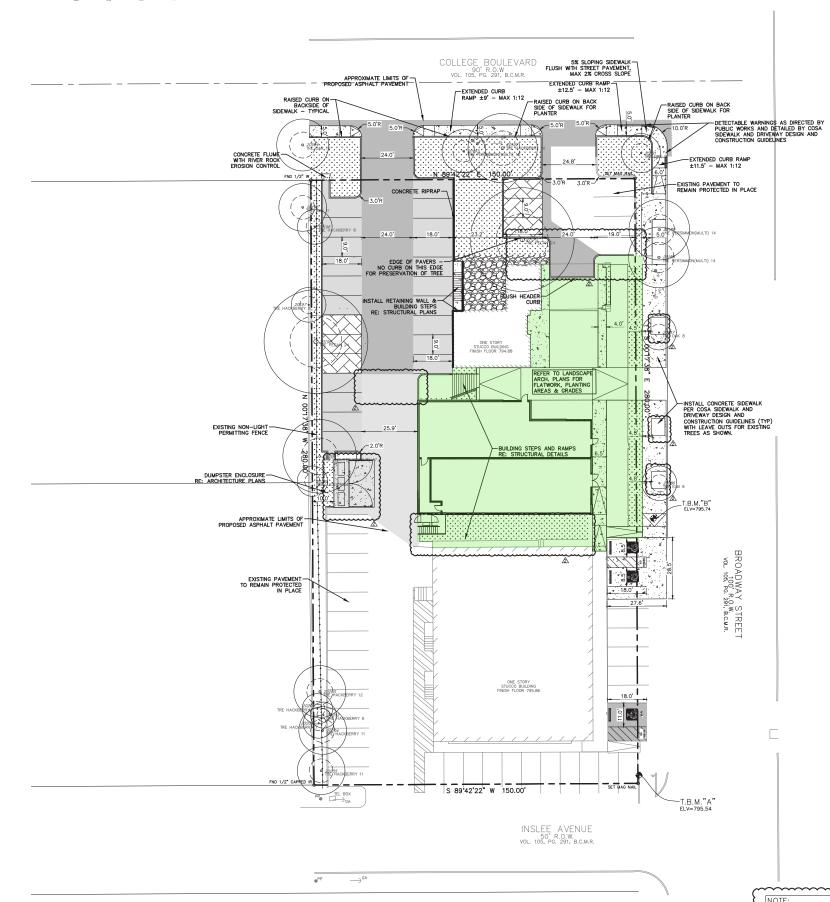
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	05/12/2023	DEMOND 2
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STATU	S	100% CD
PROJE	CT NUMBER	220050
- COM	MICHET DOOR	SCHAUM/SHIEH
DATE		05/12/2023
SCALE		AS NOTED

EXISTING CONDITIONS TREE SURVEY & DEMO





TRAFFIC & PARKING SUMMARY TABLE 6400 BLOCK OF BROADWAY STREET								
BUILDING AREAS EXISTING BUILDING AREA (SF) PROPOSED BUILDING AREA (SF) TOTAL BUILDING AREA (SF)	7,950 4,278 12,228							
PARKING STORAGE STANDARDS PARKING RATIO PER VARIANCE PARKING PROVIDED: ACTUAL PARKING RATIO:	1 SPACE PER 200 SF 64 SPACES 1 SPACE PER 190 SF							
HANDICAP SPACE (ADA) REQUIRED REGULAR HC PARKING REQUIRED V.A. PARKING PROPOSED HC PARKING	3 SPACES 1 SPACES 3 SPACES (1 V.A.)							
IMPERVIOUS COVER IMPERVIOUS COVER EXISTING (SF): IMPERVIOUS COVER PROPOSED (SF): FLOOR TO AREA RATIO (SF):	29,887 36,257 0.29:1							

CONTRACTOR TO OBTAIN REQUIRED FIRE SPRINKLER AND FIRE ALARM PERMITS PER ALAMO HEIGHTS FIRE DEPARTMENT COMMENTS.

LEGEND								
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0	IRON ROD FOUND							
⊕ <sup>ICV</sup> 11"	XIRRIGATIONACONTROLO VALVE							
→ GA	GUY ANCHOR							
● <sup>PP</sup>	POWER POLE							
™WM	WATER METER							
-Ó- <sup>FH</sup>	FIRE HYDRANT							
$\oplus^{WV}$	WATER VALVE							
⊕ <sup>GV</sup>	GAS VALVE							
<b>*</b>	BENCHMARK							
	TREE							

PROPOSED IRRIGATION CONTROL VALVE

PROPOSED LIGHT-DUTY ASPHALT PAVEMENT DECOMPOSED GRANITE RE: LANDSCAPE ARCHITECT'S PLANS

PROPOSED HEAVY-DUTY 8"CONCRETE PAVEMENT

PROPOSED LANDSCAPING

REFER TO LANDSCAPE PLANS FOR HARDSCAPE AND LANDSCAPE BETWEEN BUILDINGS AND SURROUNDING NEW BUILDING

NOTE: SURVEY WAS PERFORMED BY WINDROSE SURVEYING & LAND SERVICES, LLC. CONTACT COREY CAMPBELL AT (210)634-1565 FOR ANY SURVEY QUESTIONS, COORDINATION OR NEEDS.

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PROJECT

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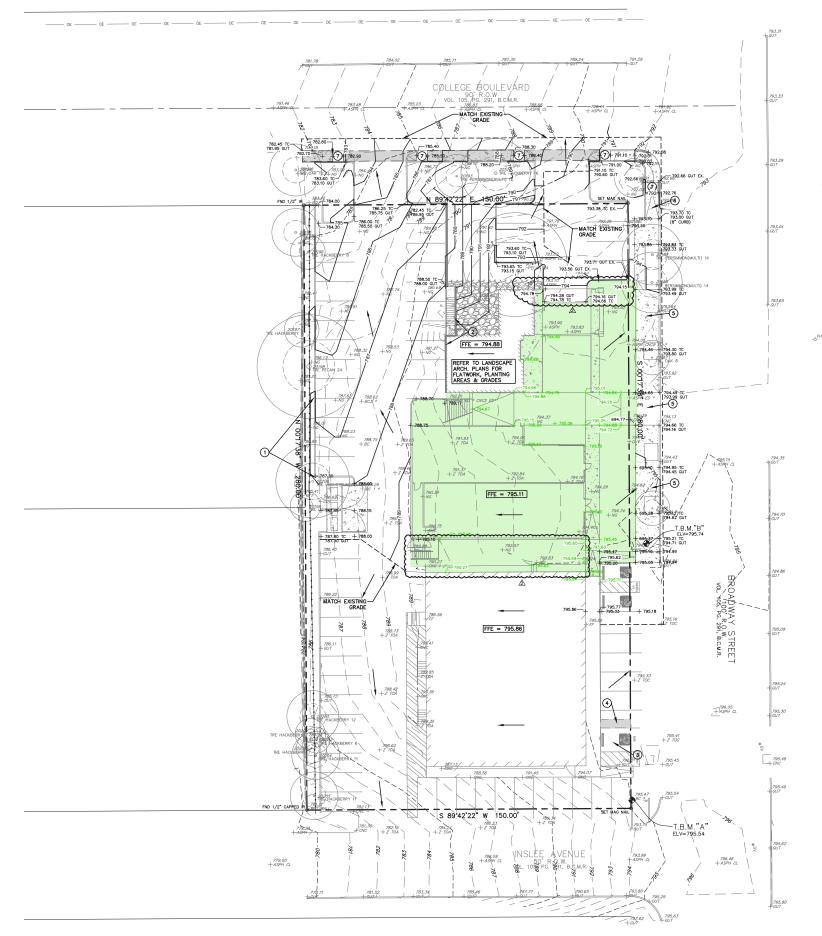
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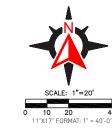


03/13/2023 TAS\_REVISION 05/12/2023 REVISION 2

NO DATE

SITE PLAN & PAVING PLAN





## **KEY NOTES**

- 1 EXTENT OF TALL CURB VARYING IN HEIGHT FROM 6 INCHES TO 18 INCHES
- 2 RETAINING WALLS RE: STRUCTURAL PLANS
- 3 NEW ASPHALT @ MAX 2% SLOPE
- 4 USE STRIP FOR TRANSITION TO ALLOW 2% SLOPE ON ACCESSIBLE PARKING
- 5 MAX 2% CROSS SLOPE, RUNNING SLOPE TO MATCH PUBLIC STREET
- (6) 12' CURB RAMP
- 7 LEVEL LANDING

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	WASTEWATER LINE WATER LINE STORM SEWER LINE OVERHEAD ELECTRIC
0	IRON ROD FOUND
⊕ICV	IRRIGATION CONTROL VALVE
→ GA	GUY ANCHOR
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NW	WATER METER
-Ó-FH	FIRE HYDRANT
$\mathrm{e}^{\mathrm{WV}}$	WATER VALVE
⊕ <sup>GV</sup>	GAS VALVE
•	BENCHMARK



PROPOSED IRRIGATION CONTROL VALVE



DRAINAGE FLOW ARROWS



+600 PROPOSED LANDSCAPE ARCHITECT SPOT ELEVATION

+600PROPOSED SPOT ELEVATION

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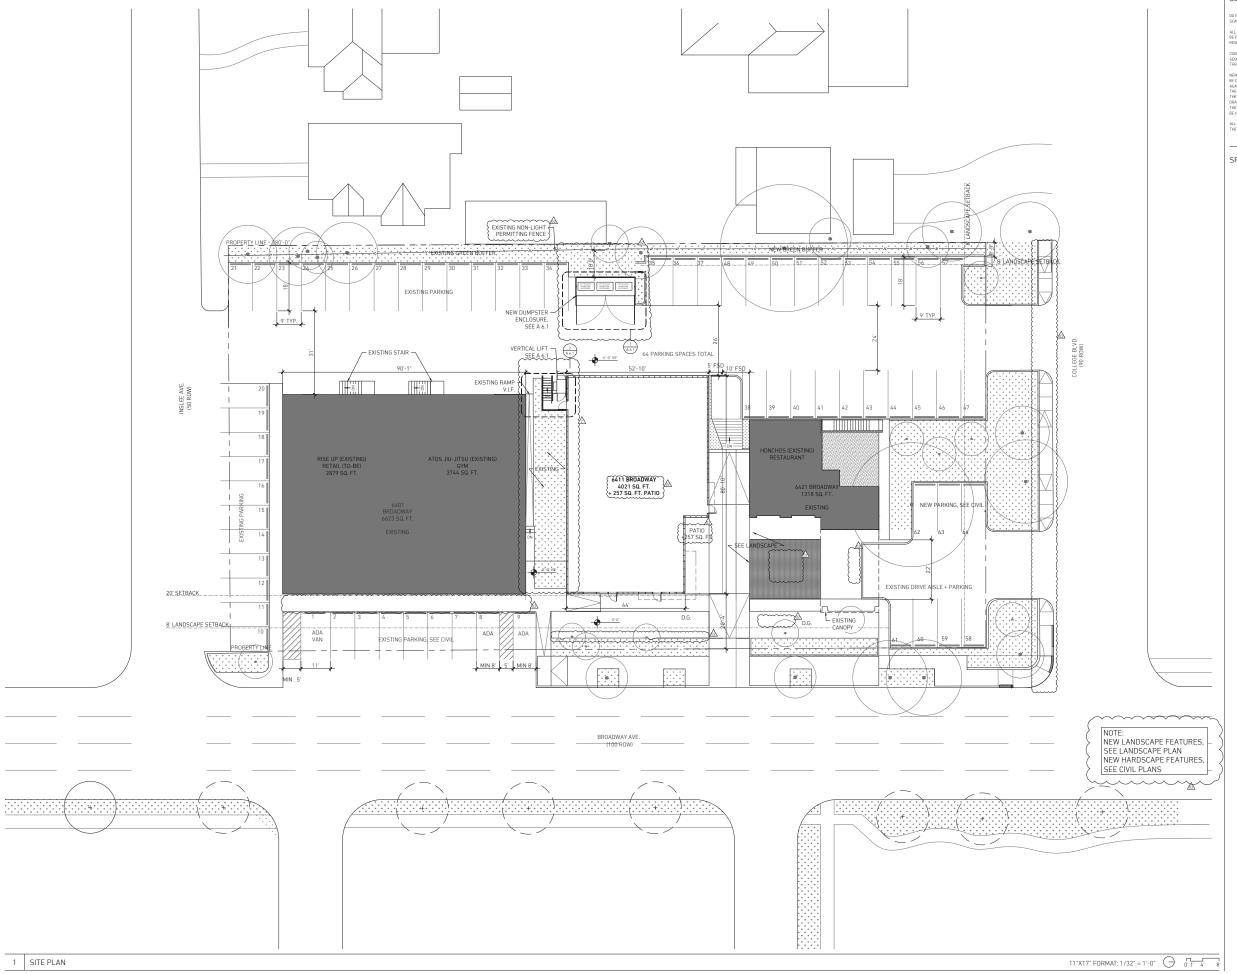
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03/13/2023 TAS\_REVISION 05/12/2023 REVISION 2

NO DATE

GRADING PLAN



## GENERAL SHEET NOTES

## SPECIFICATION

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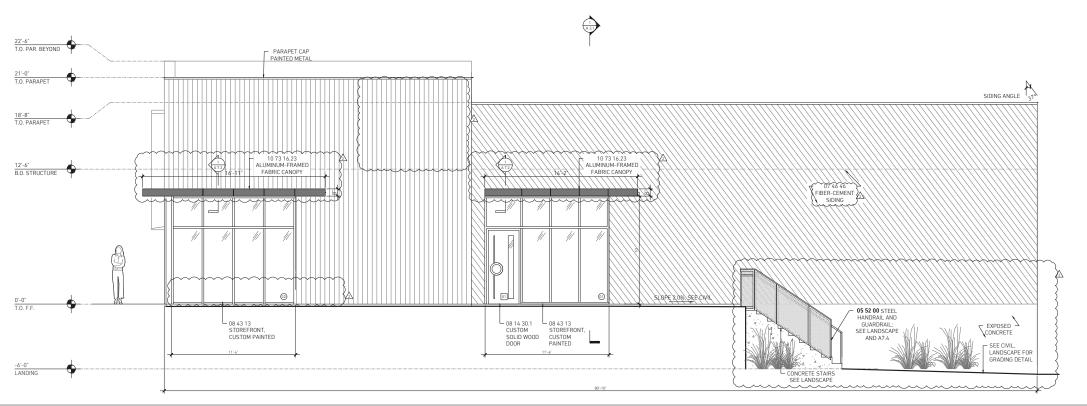
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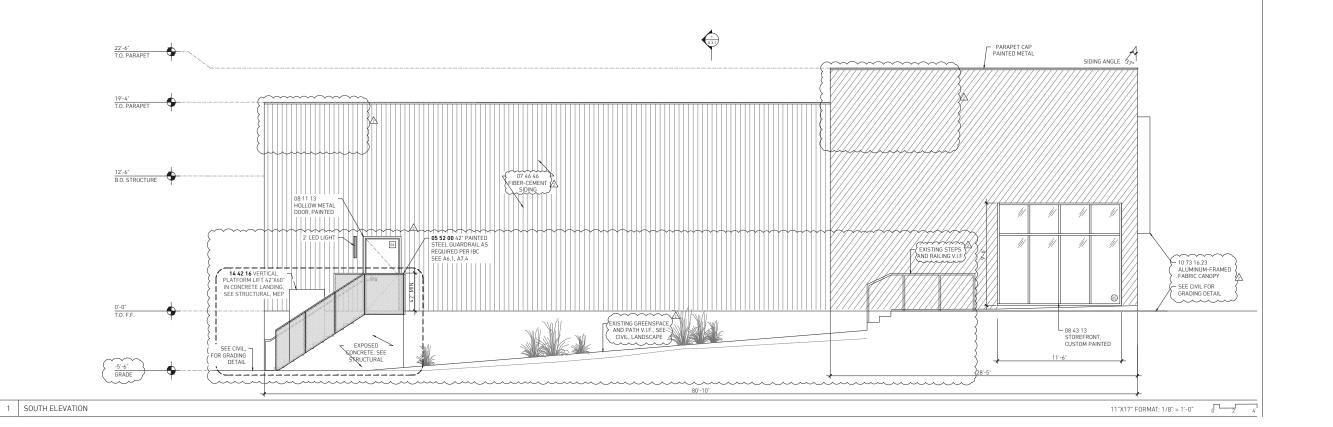
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OVERALL SITE PLAN

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2 NORTH ELEVATION 0, 2, / 11"X17" FORMAT: 1/8" = 1'-0"



## GENERAL SHEET NOTES

## SPECIFICATION

05 52 00 METAL RAILINGS 07 46 46 FIBER-CEMENT SIDING

08.80.00 GLAZING

## 10 73 16. 23 FABRIC AWNING

14 42 16 VERTICAL LIFT

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STRUCTURAL ENGINEER

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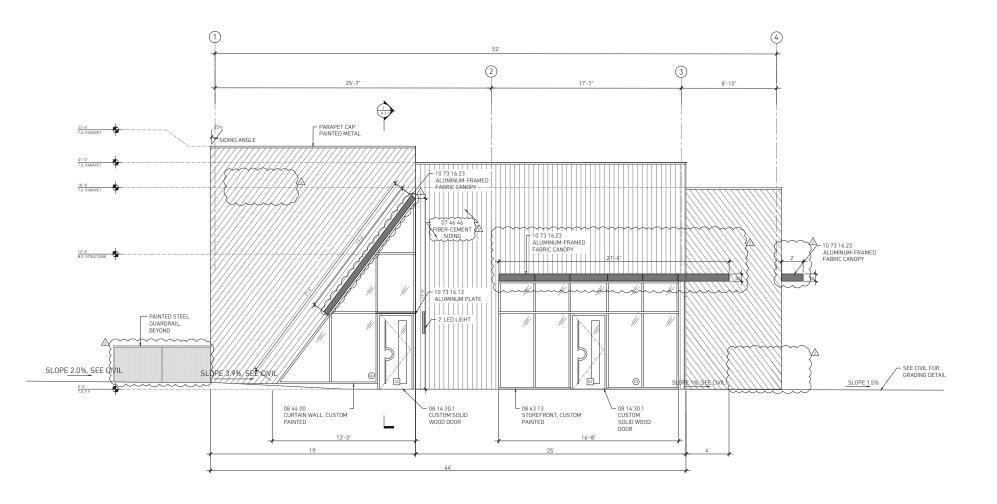
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2 EAST ELEVATION 0' 2' 11"X17" FORMAT: 1/8" = 1'-0" 4 1 2 3 22'-6" T.O. PARAPET - 07 62 33 SCUPPER 07 62 33 SCUPPER \_ 07 62 33 SCUPPER 21'-0" T.O. PARAPET O7 62 33 EMERGENCY OVERFLOW SCUPPER 12'-6" B.O. STRUCTURE EXISTING BUILDING 6401 BROADWAY 05 52 00 STEEL HANDRAIL O5 52 00 PAINTED STEEL GUARDRAIL, SEE A6.1, A7.4 AND GUARDRAIL; SEE LANDSCAPE AND A7.4 CONCRETE STAIRS SEE STRUCTURAL, LANDSCAPE 1 WEST ELEVATION 11"X17" FORMAT: 1/8" = 1'-0" 0 2 4

## GENERAL SHEET NOTES

## SPECIFICATION

## 07 46 46 FIBER-CEMENT SIDING

08 80 00 GLAZING SOLARBAN 70 (2) SOLEXIA + CLEAR GLASS INSULATING GLASS UN

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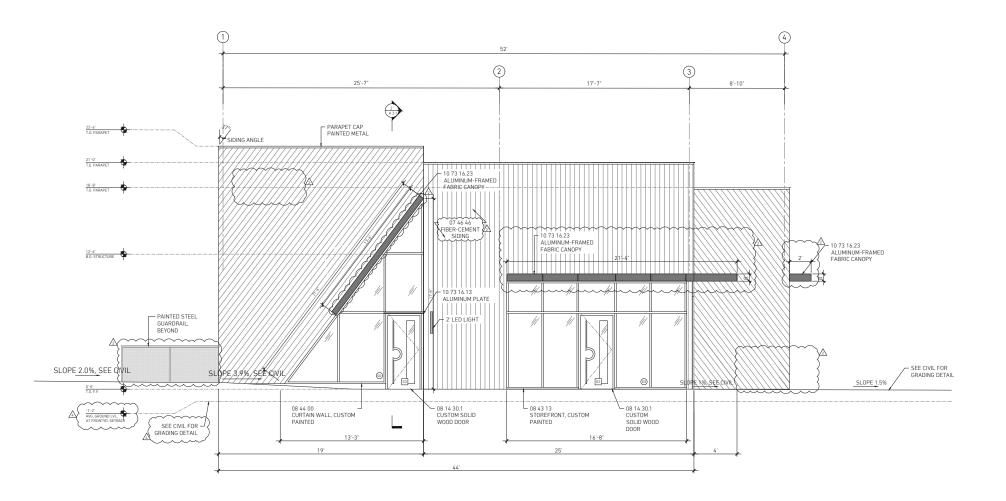
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ELEVATION

A 2.2



2 EAST ELEVATION 0' 2' 11"X17" FORMAT: 1/8" = 1'-0" 4 1 2 3 22'-6" T.O. PARAPET - 07 62 33 SCUPPER 07 62 33 SCUPPER \_ 07 62 33 SCUPPER 21'-0" T.O. PARAPET O7 62 33 EMERGENCY OVERFLOW SCUPPER 12'-6" B.O. STRUCTURE EXISTING BUILDING 6401 BROADWAY 05 52 00 STEEL HANDRAIL O5 52 00 PAINTED STEEL GUARDRAIL, SEE A6.1, A7.4 AND GUARDRAIL; SEE LANDSCAPE AND A7.4 CONCRETE RETAINING WALL BEHIND STAIRS, SEE CONCRETE STAIRS SEE STRUCTURAL, LANDSCAPE 1 WEST ELEVATION 11"X17" FORMAT: 1/8" = 1'-0" 0 2 4

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## AH COMMERCIAL

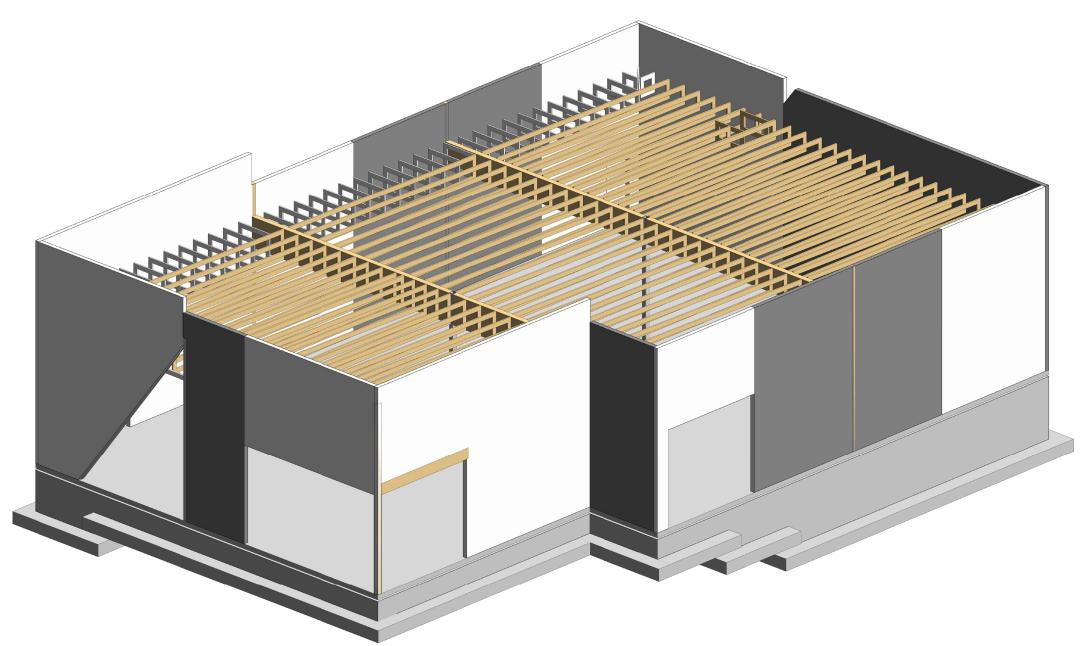
6411 Broadway Alamo Heights, TX 78209



ISSUE		
2	05/12/23	REVISION
4	08/24/23	REVISION
	DATE	TITLE
STATUS		100% CD
PROJECT		2203
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DATE		01/20/2023
SCALE		AS NOTED

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1 PRESENTATION 3D VIE

SHEET LIST						
Sheet Number	Sheet Name					
S001	3D VIEW AND SHEET LIST					
S101	GENERAL STRUCTURAL CRITERIA					
S102	GENERAL STRUCTURAL CRITERIA					
S200	FOUNDATION PLAN - OVERALL					
S201	FOUNDATION PLAN					
S202	SITE FOUNDATION PLANS					
S203	ROOF FRAMING PLAN					
S301	FOOTING & PLINTH SCHEDULE & DETAILS					
S302	CONT. FOOTING SCHEDULE & DETAILS					
S303	COLUMN SCHEDULES & DETAILS					
S401	TYPICAL FOUNDATION DETAILS					
S402	TYPICAL FOUNDATION DETAILS					
S403	TYPICAL SITE FOUNDATION DETAILS					
S501	TYPICAL FRAMING DETAILS					
S502	TYPICAL FRAMING DETAILS					
S701	ROOF FRAMING DETAILS					
S702	ROOF FRAMING DETAILS					
S703	MISC FRAMING DETAILS					

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LNOSCARE ARCHITECT

LANDSCAPE ARCHITECT

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2023-01-20

CONSTRUCTION DRAWINGS

3D VIEW AND SHEET LIST

9800 Richmond Avenue, Suite 460 Houston, Texas 77042 t 713 337 8881 Texas Registered Engineering Firm F-003426

PROJECT #: 22-398

S001

<u>EW</u>	Passociates STRUCTURAL   CIVIL
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